

repairs to the TOWERS OF PONCE INLET - BUILDING 500 4545 South Atlantic Avenue Ponce Inlet, Florida





					λ		
			PI	ROJECT DIRECTORY	INDEX of DI	RAWINGS	
			ENGINEER OF REC	•	S-0 COVER SHEET		
					S-1 CONCRETE REPAIR PRO	OCEDURES & DETAILS	
					S-2 1ST FLOOR REPAIR PLAN		
						S-2IbTTECONTREPARTEMENTERS-32ND FLOOR REPAIR PLANS-43RD FLOOR REPAIR PLAN	
		XIII.					
						S-5 4TH FLOOR REPAIR PLA	
					Charles R. Adams	S-6 5TH FLOOR REPAIR PL	
					& Associates, Inc.	S-7 6TH FLOOR REPAIR PL	AN
				s s	TRUCTURAL ENGINEERS	S-8 7TH FLOOR REPAIR PL	AN
				414 Canal Street -	New Smyrna Beach, FL 32168 - 386.426.5583	S-9 ROOF REPAIR PLAN	
				TTT Canal Street -	C.R. 4180		
Land and the second					0.11. 4100		
	the same and the			ARCHITECT:			
LOCATION MAP		ABBRI	EVIATIONS	_	N/A		
		AC	AIR CONDITIONING	-			
A REAL PROPERTY AND A REAL		AFF ALUM	ABOVE FINISHED FLOOR ALUMINUM				
		CLG CMU	CEILING CONCRETE MASONRY UNIT				
		COLCOLUMNCONCCONCRETE		GENERAL CONTRACTOR:		SCOPE O	FWORK
		CONT C/L	CONTINUOUS CENTER LINE	T.B.D.		COMMERCIAL - CONCRETE REPAIRS	
		DBL DIA	DOUBLE DIAMETER				
		DIM EA	DIMENSION EACH				
		ELEC ELEV/EL	ELECTRICAL ELEVATION		WIND LOAD DATA	GENERAL BUI	LDING DATA:
EQ EQUAL EXIST EXISTING CALV CALVANIZED			BASIC WIND SPEED: 140 CATEGORY I ENCLOSED BUILDING		AREA CALCULATIONS		
		GALV GALVANIZED			CONDITIONED LIVING:	N/A	
	4545 SOUTH ATLANTIC AVENUE,	GYP HDW HVAC	HARDWARE HEATING, AIR CONDITIONING & VENT	WIND EXPOSURE	D	-	-
	PONCE INLET, FL.	INFO	INFORMATION	WIND PRESSURE FOR COMPO	ONENTS & CLADDING: (ASD)	TOTAL AREA OF PROJECT:	
		INSUL INSULATION MAS MASONRY	MASONRY	ZONE:	PRESSURE (psf):		
		MAX MECH	MAXIMUM MECHANICAL	ZONE 1 ZONE 2	+12.78, -26.10 +12.78, -42.08	PROJECT CO	
Permano Br		MFGR/MFR MIN	MANUFACTURER MINIMUM	ZONE 2 ZONE 3	+12.78, -58.59	FLORIDA BUILDING CODE - 7th ED NATIONAL ELECTRICAL CODE	DITION 2020 2020
		MTL NA	METAL NOT APPLICABLE			UNIFORM PLUMBING CODE	2021
		NIC NOM	NOT IN CONTRACT NOMINAL			FL. FIRE PREVENTION CODE NFPA 101 LIFE SAFETY CODE	2020 2021
OC ON CEN		NOT TO SCALE ON CENTER	ZONE 4	39.0, -39.0	NFPA-1 UNIFORM FIRE CODE	2021	
		PLYWOOD PREFABRICATED	ZONE 5 WIND LOAD DAT	39.0, -71.3	ACCESSIBILITY CODE ENERGY CODE	2021 2021	
		PSF PT	POUNDS PER SQUARE FOOT PAINT/PRESSURE TREATED	MECAWIND 2.1.0		ACI 318 / 19	2019 2016
		RCP REBAR	REFLECTED CEILING PLAN REINFORCING BAR	PROGRAM FOR A		ASCE 7-16	
$ \begin{array}{c} $	ELEVATION HT	REF REINF	REFENCE REINFORCE		JURISDICTION	REVISION LOG	CHARLES R ADAMS Professional Engineer
		REQD RO	REQUIRED ROUGH OPENING	CITY OF PONC	CE INLET, FLORIDA	DATE DESCRIPTION	
# A#SECTION#	DOOR NUMBER	SIM SPEC	SIMILAR SPECIFICATION				This item has been digitally signed and sealed by Charles R. Adams on the date indicated here. Printed copies, of this
	WINDOW NUMBER	SS STL	STAINLESSSTEEL STEEL	STATEMENT OF COMPLIANCE			Charles R. Adams on the date indicated here. Printed copies, of this document, are not considered signed and sealed and the signature must be verified on any electronic copies.
# A#DETAIL#		STOR TPD	STORAGE TOILETPAPER DISPENSER				CENSE HE
DEVICIONI NI INTRE TYPICAL		TO THE BEST OF MY KNOWLEDGE THESE PLANS AND SPECIFICATIONS COMPLY WITH ALL APPLICABLE			A ORION . B		
(#) KEY NOTE /#		VCT VERT	VINYLCOMPOSITION TILE	BUILDING AND FI			
I WALL TYPE	ROOM NAME	WD WWF	VERTICAL WOOD MAEL DED MAIRE EABRIC				
		W/	WELDED WIRE FABRIC WITH				FLORIDA LICENSE NO. 15113

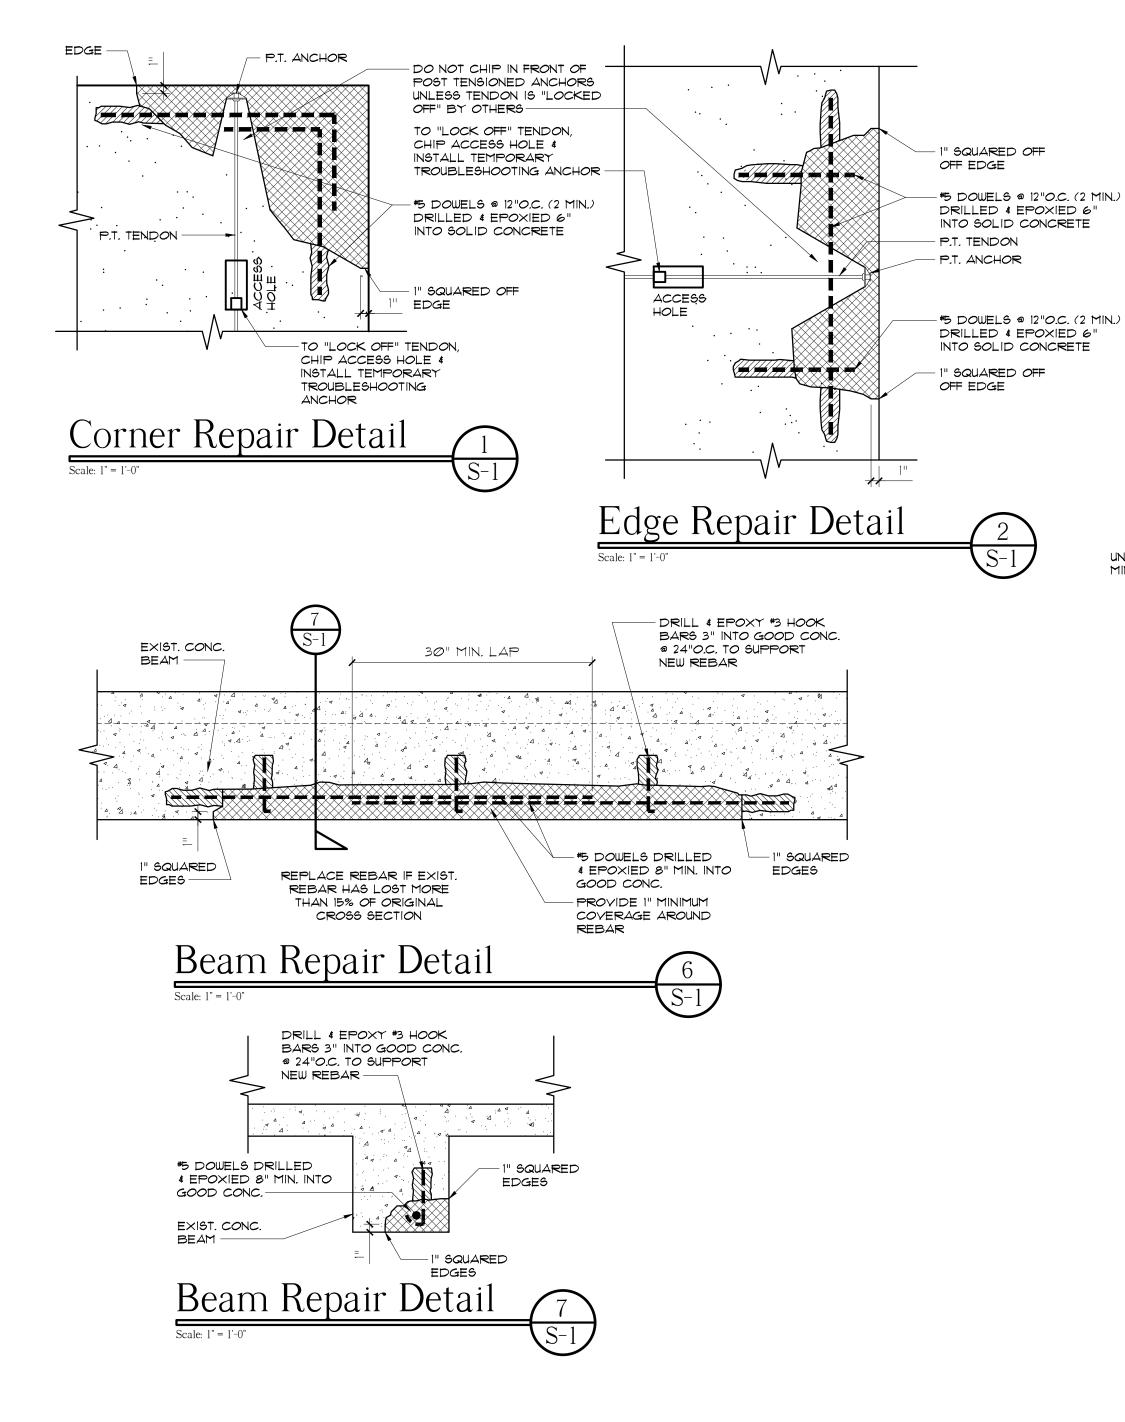

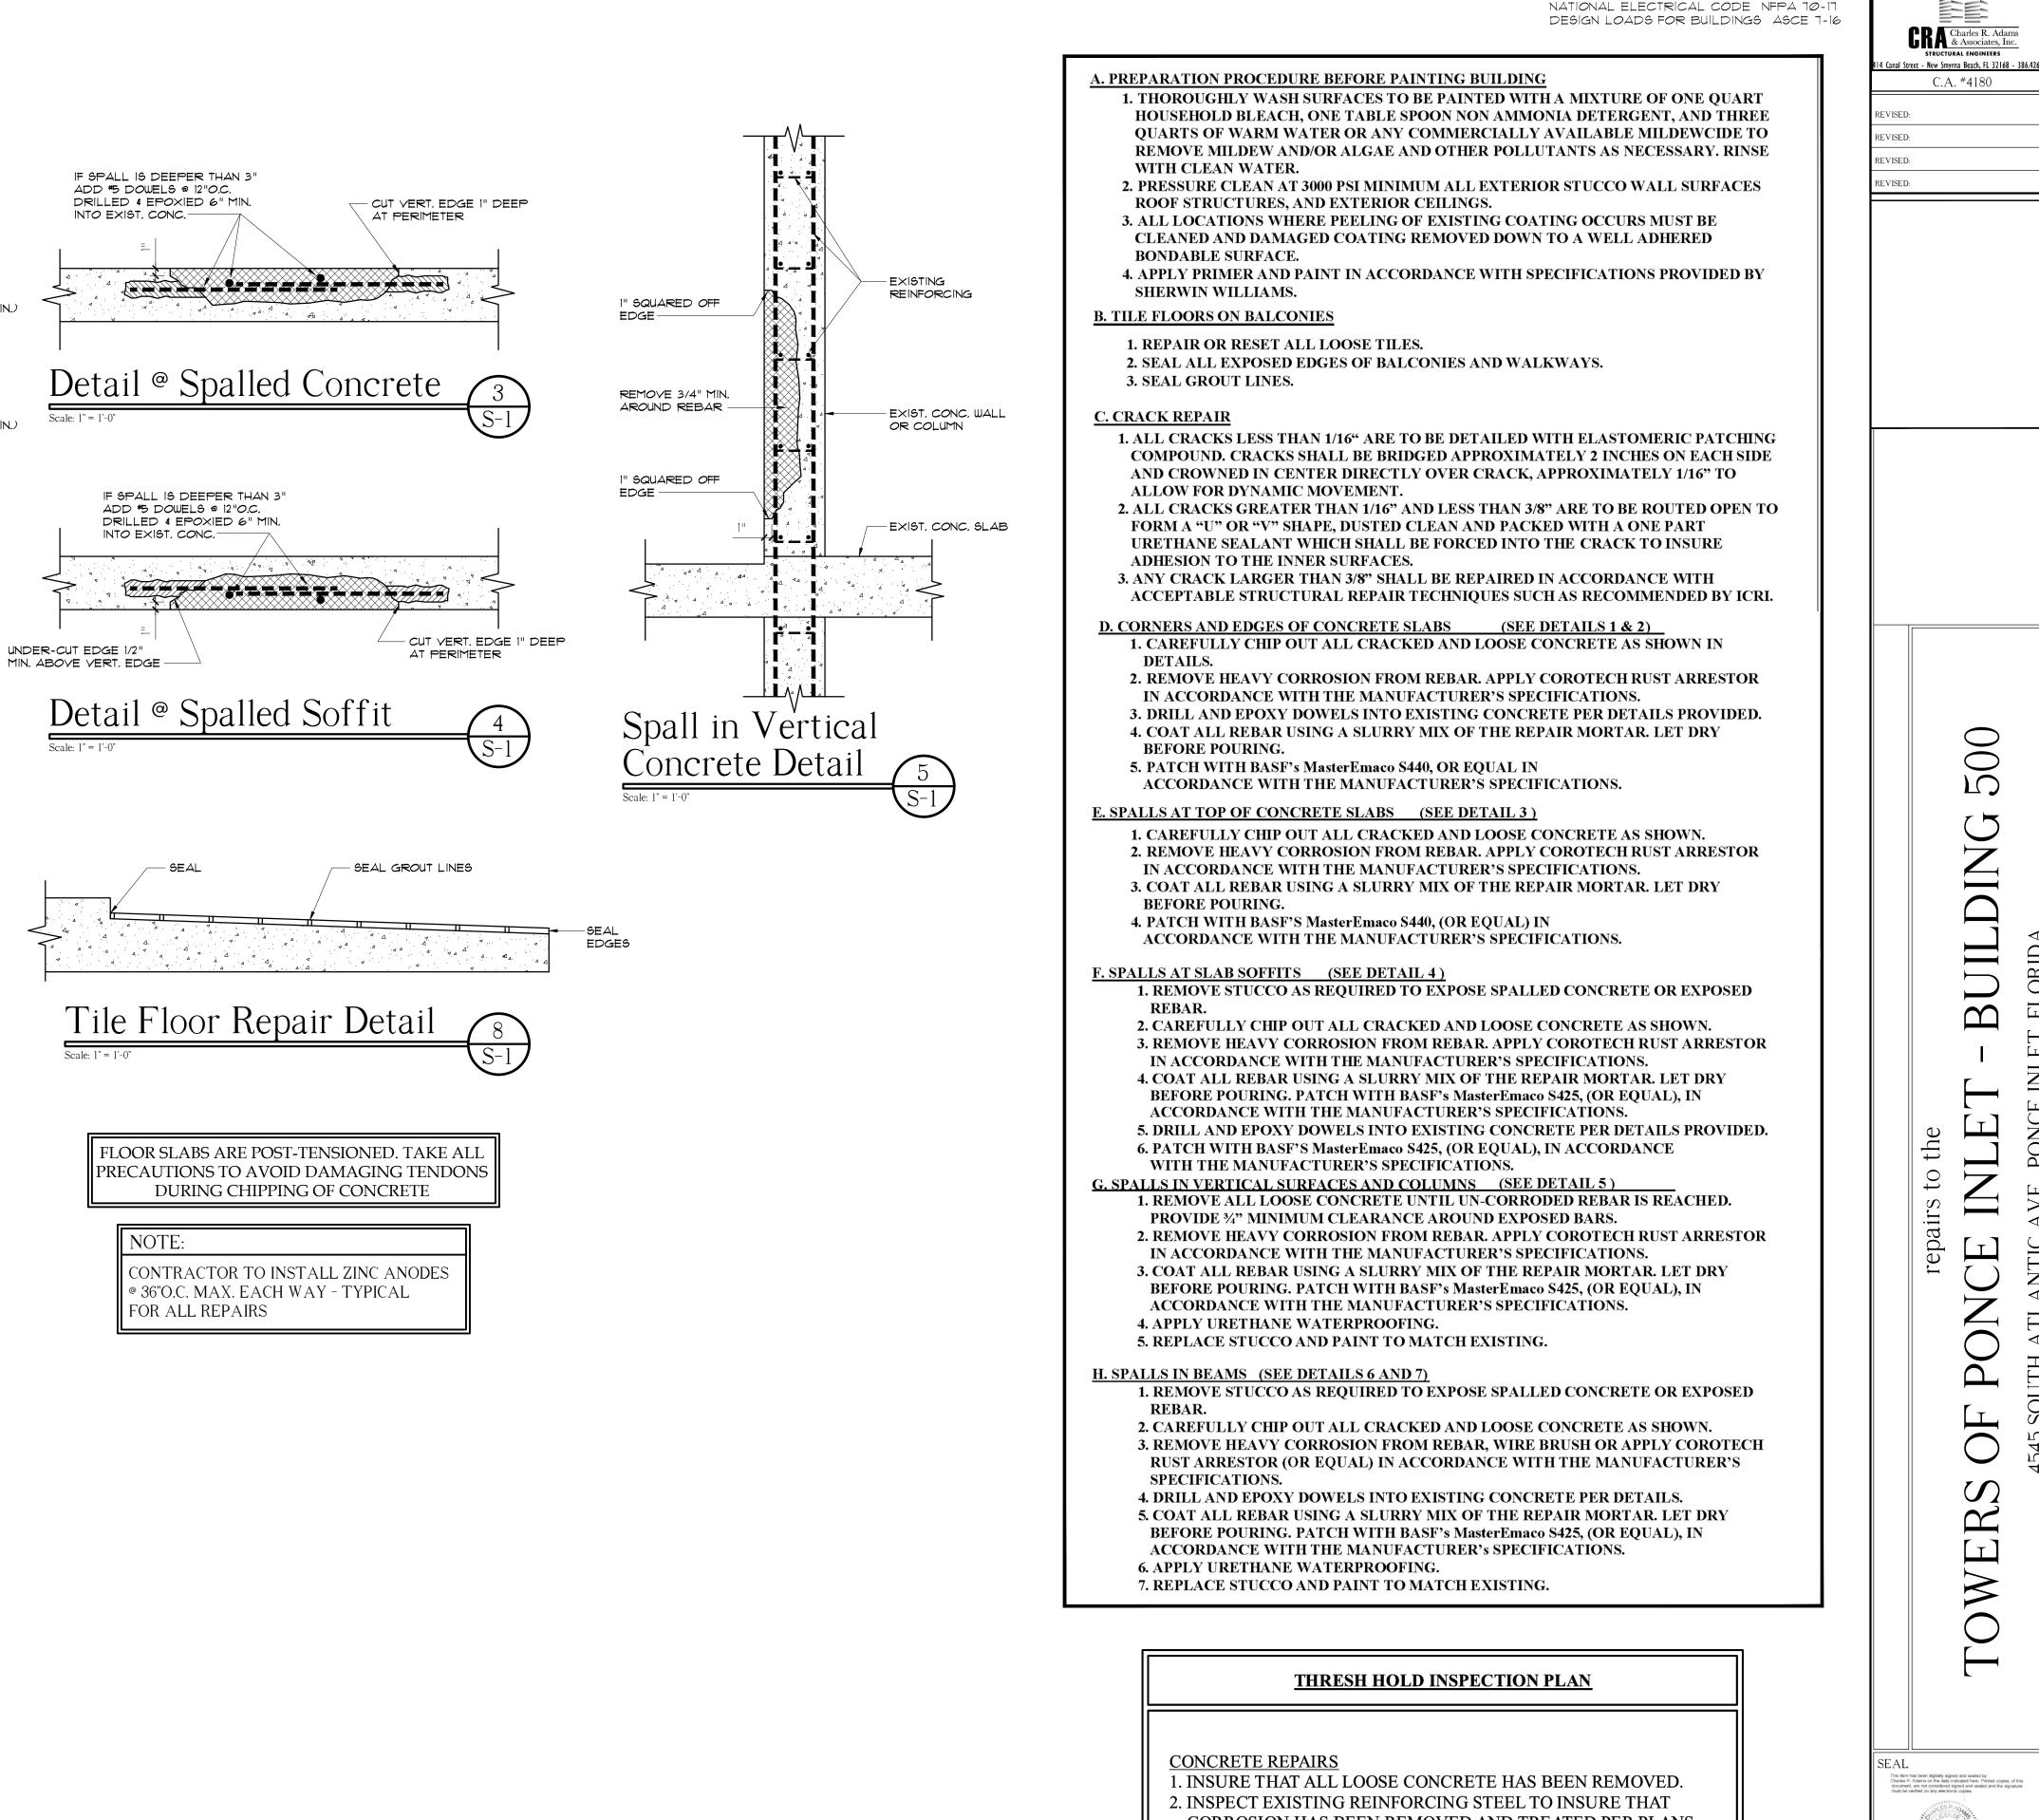

- CORROSION HAS BEEN REMOVED AND TREATED PER PLANS. 3. INSPECT QUANTITY AND INSTALLATION OF SUPPLEMENTAL REINFORCING STEEL CONFORMS TO THE PERMIT PLANS.
- 4. VERIFY APPLICATION OF CHEMICAL TREATMENTS PER PLANS. 5. CONFIRM CONCRETE PATCHING MATERIALS ARE FURNISHED AND INSTALLED IN ACCORDANCE WITH THE PERMIT PLANS.

DRAWN BY: B.J.M.


CHECKED BY: C.R.A. SCALE: AS NOTED

DATE: 01-12-2022 OF:


S-1

- 1. CORNER REPAIR
- 4. SOFFIT/CEILING REPAIR
- BEAM REPAIR

- 11. RUST SPOT / EXPOSED REIN.

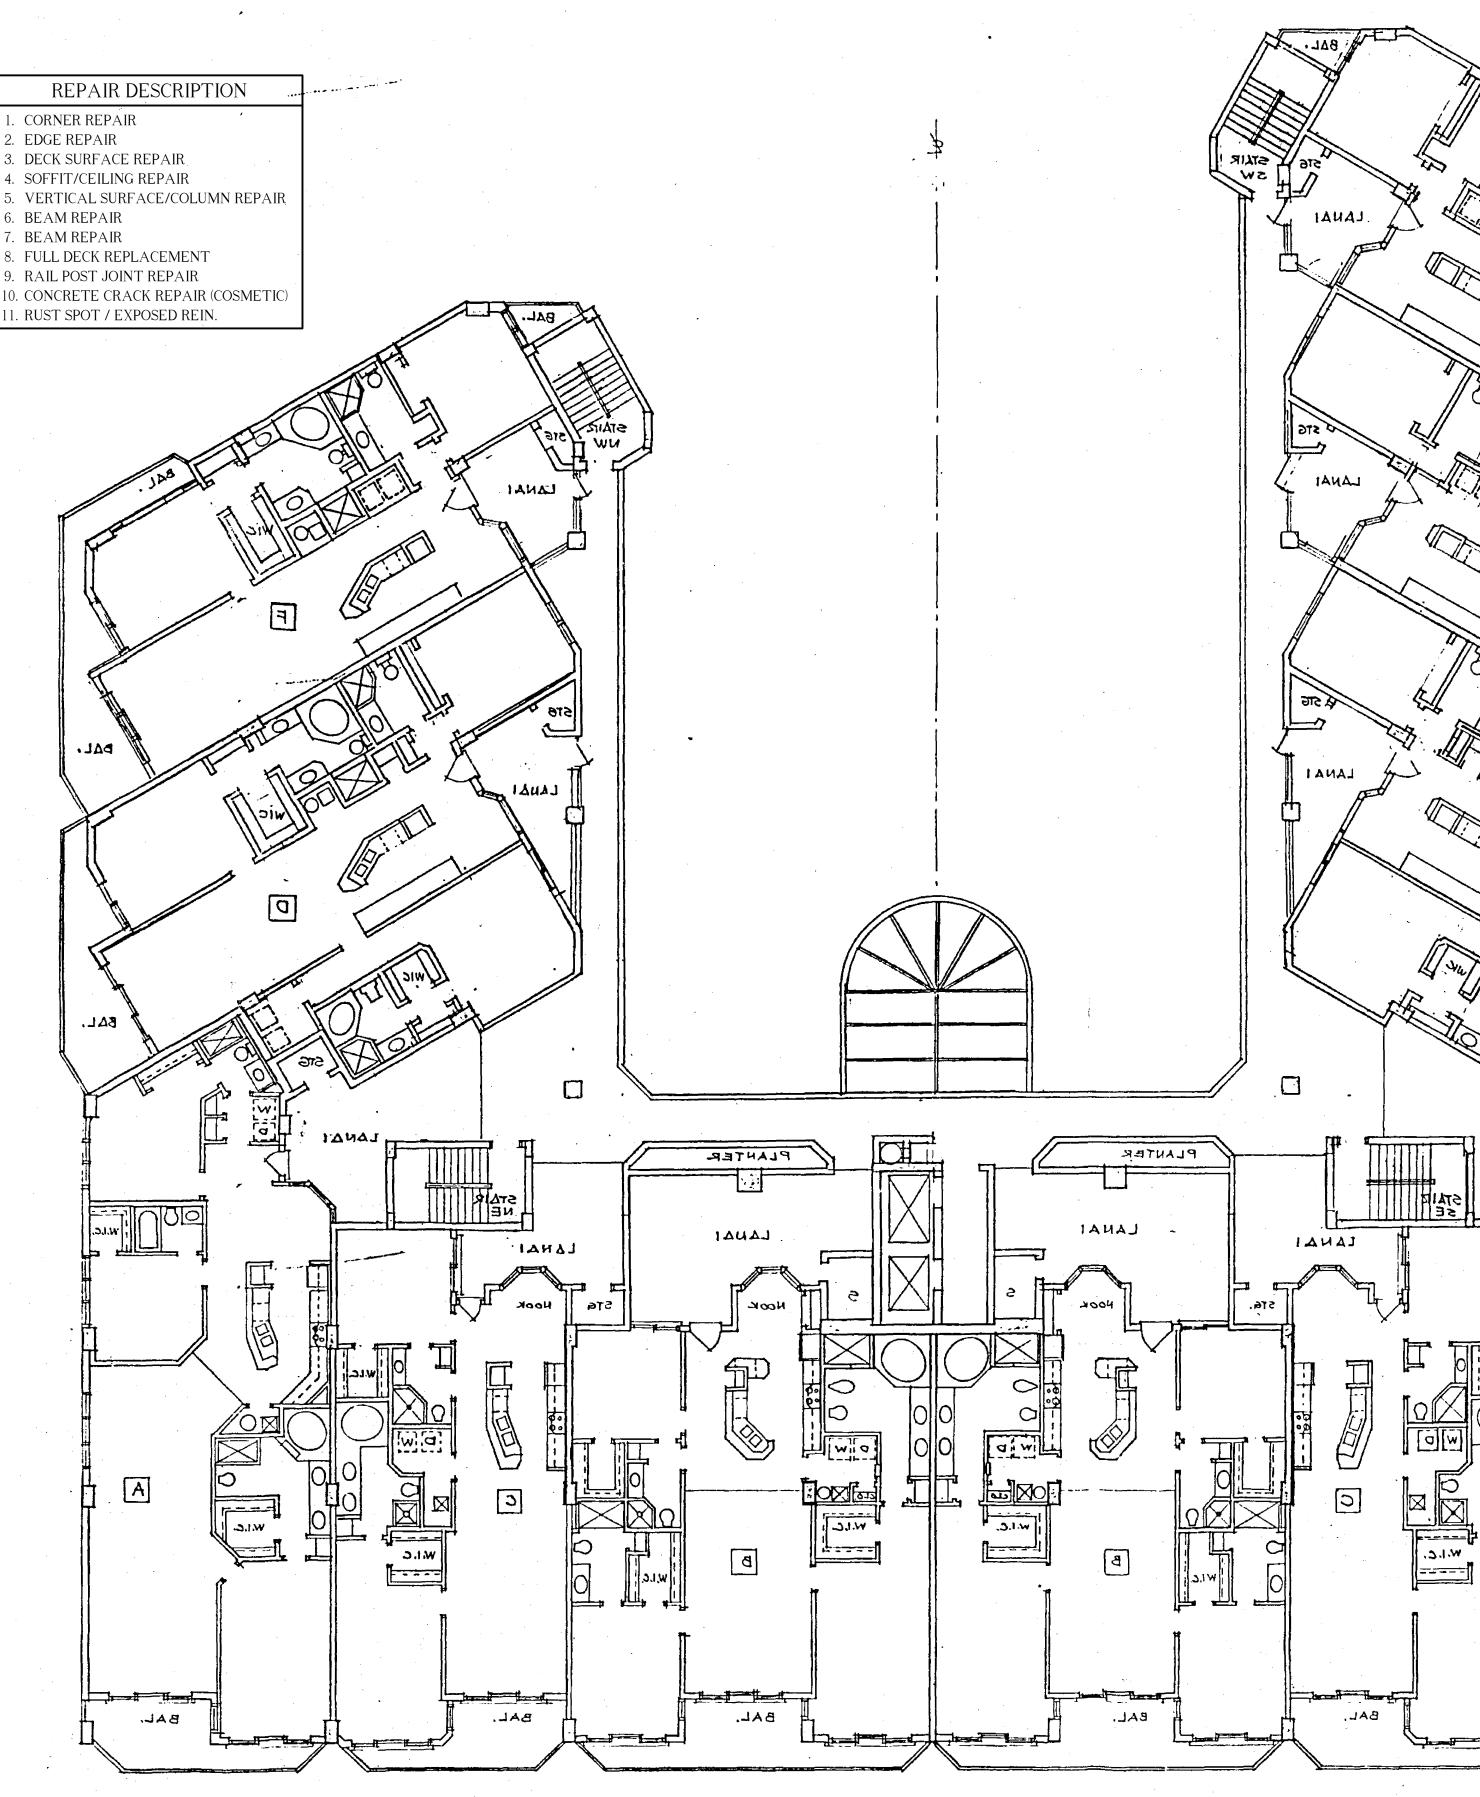


NO STRUCTURAL ISSUES DISCOVERED

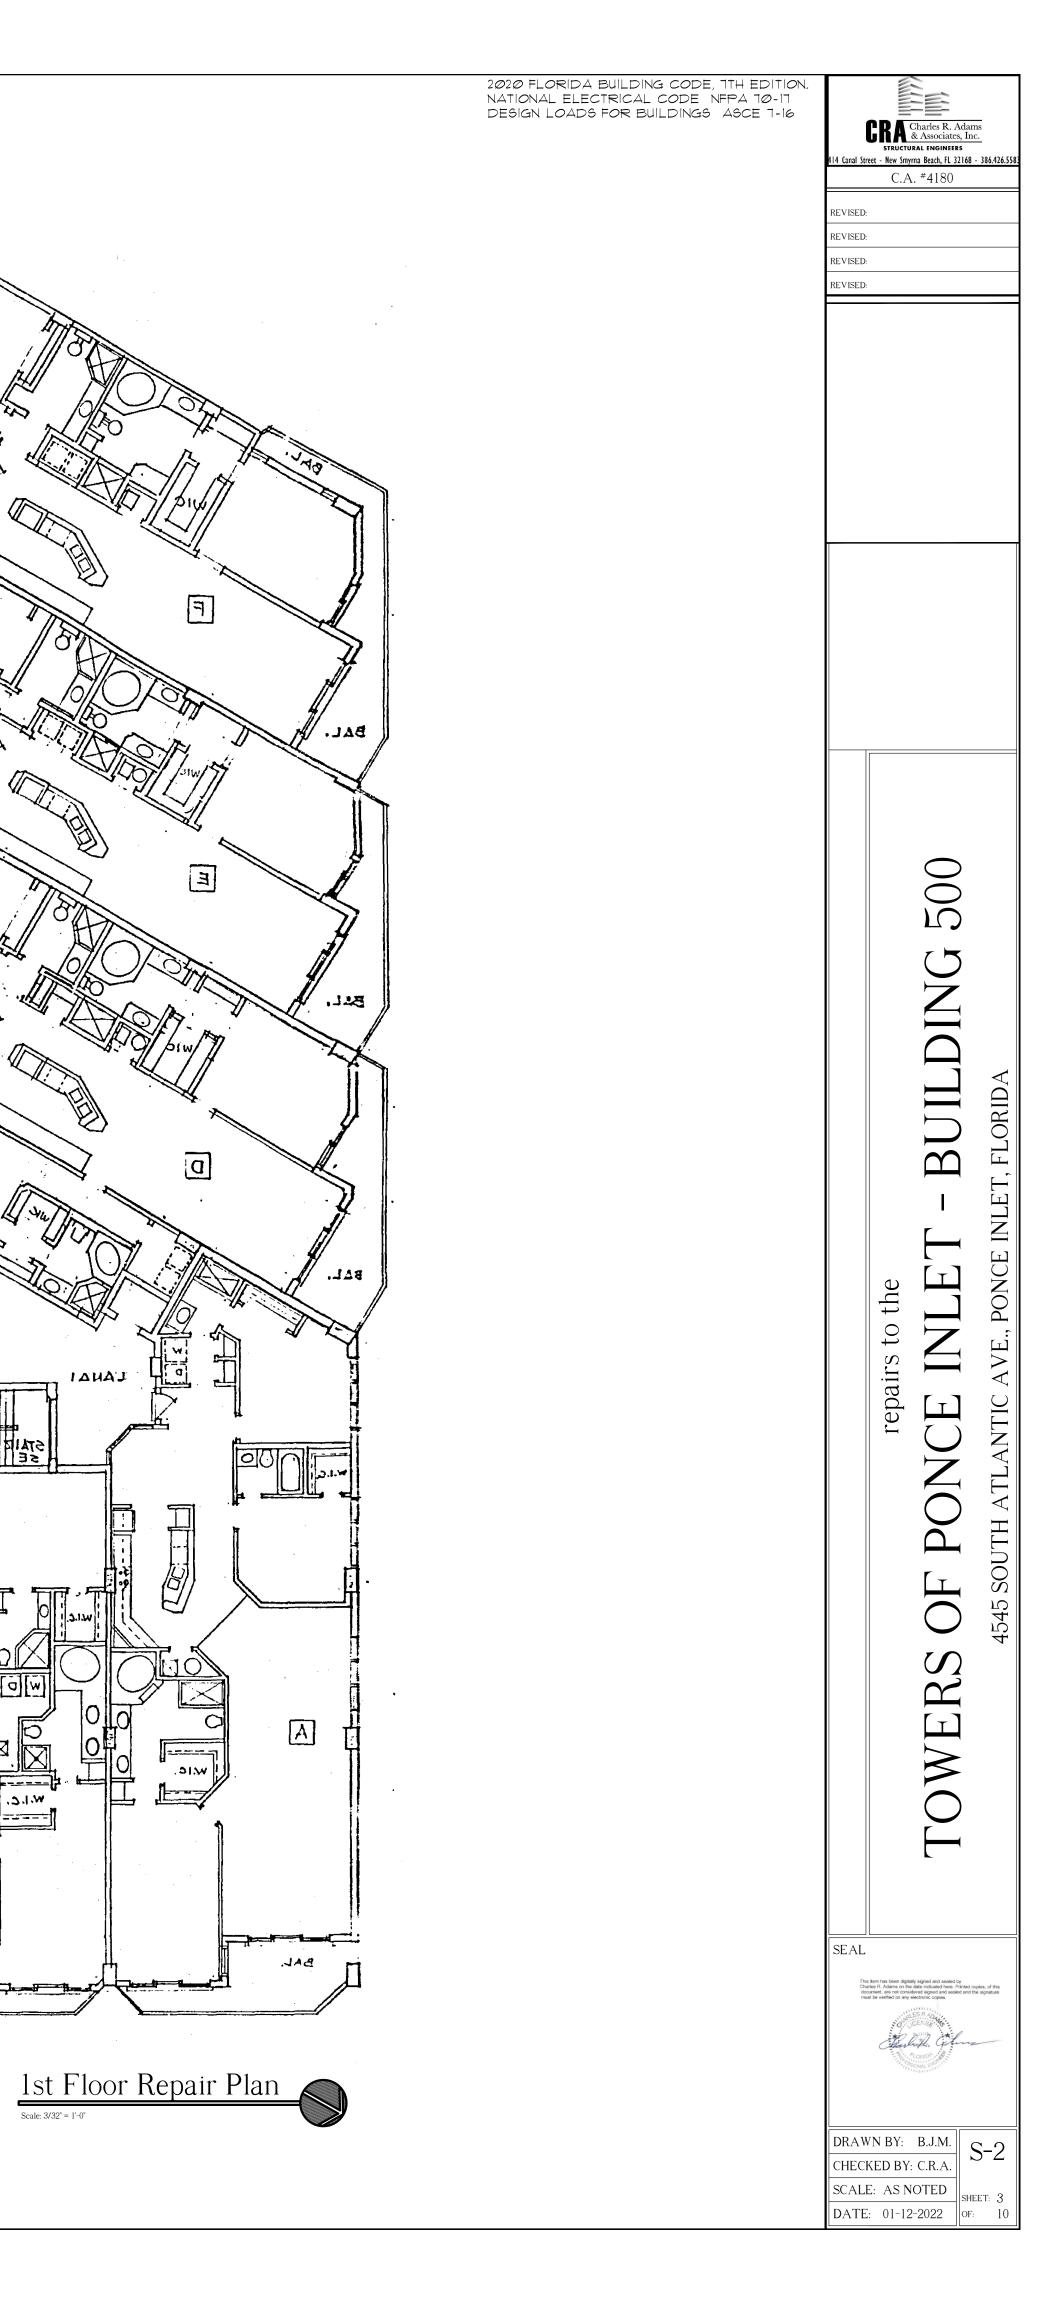


- 1. CORNER REPAIR
- 4. SOFFIT/CEILING REPAIR
- . BEAM REPAIR

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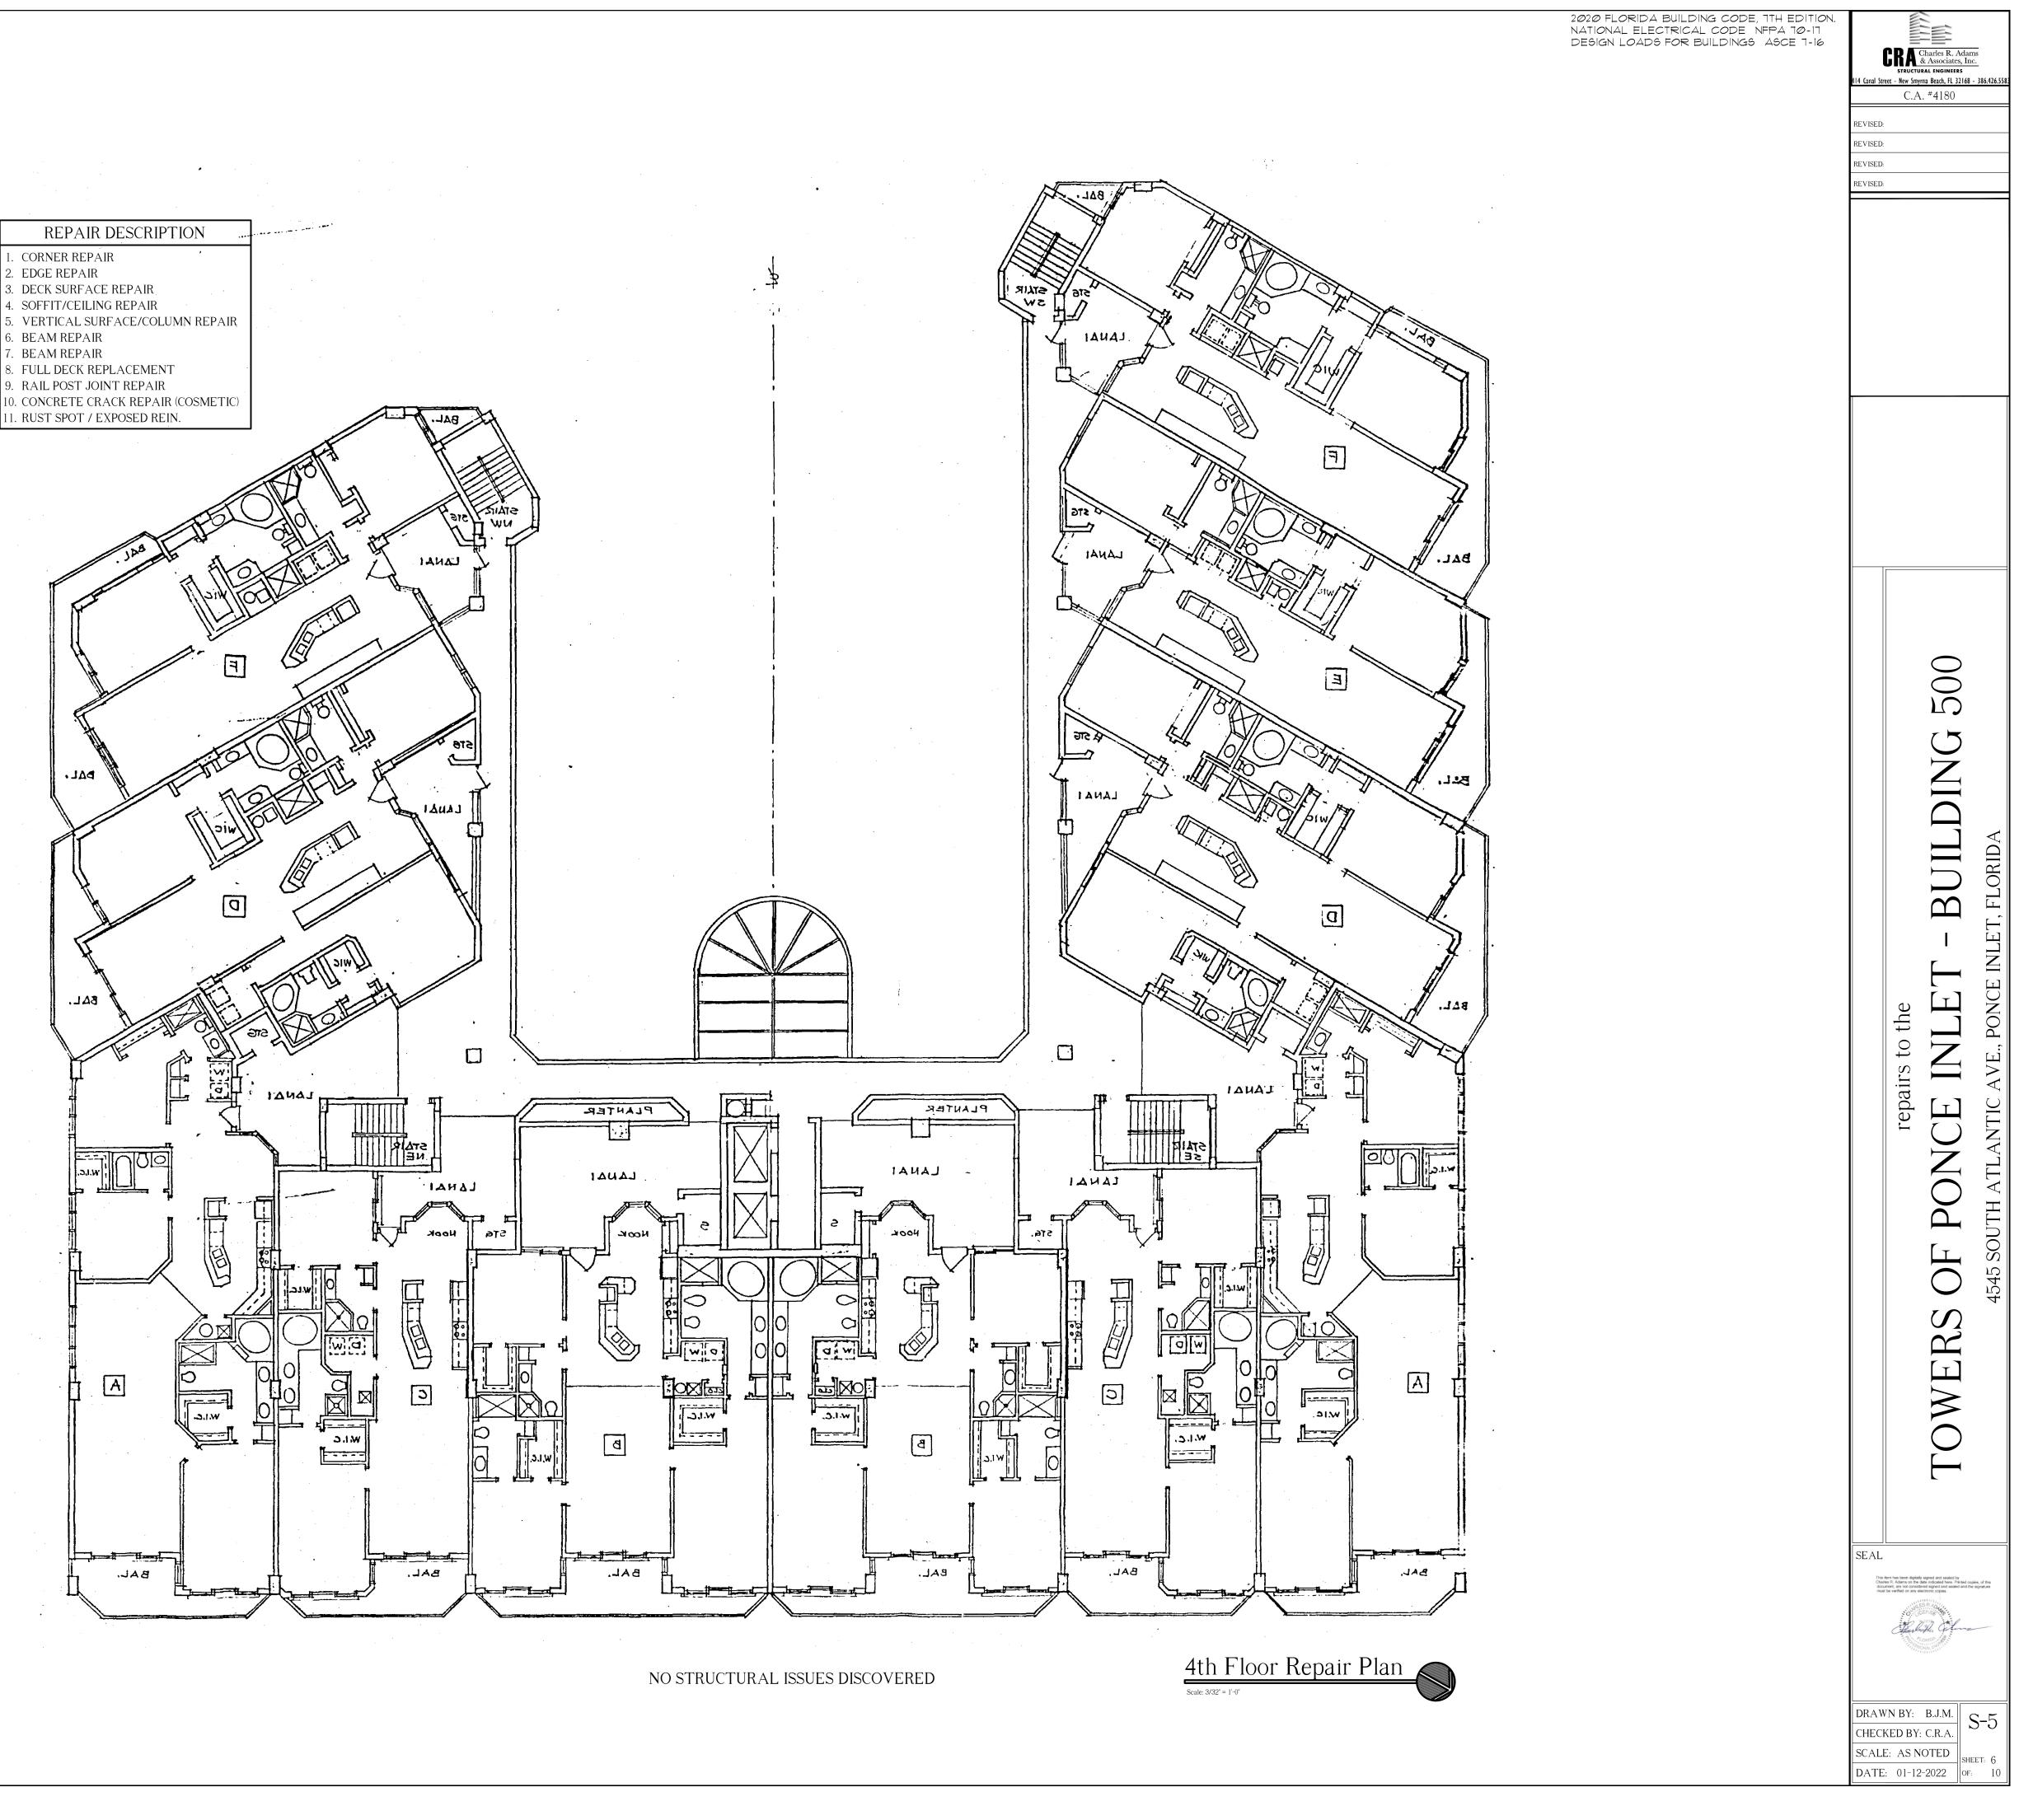
- 9. RAIL POST JOINT REPAIR

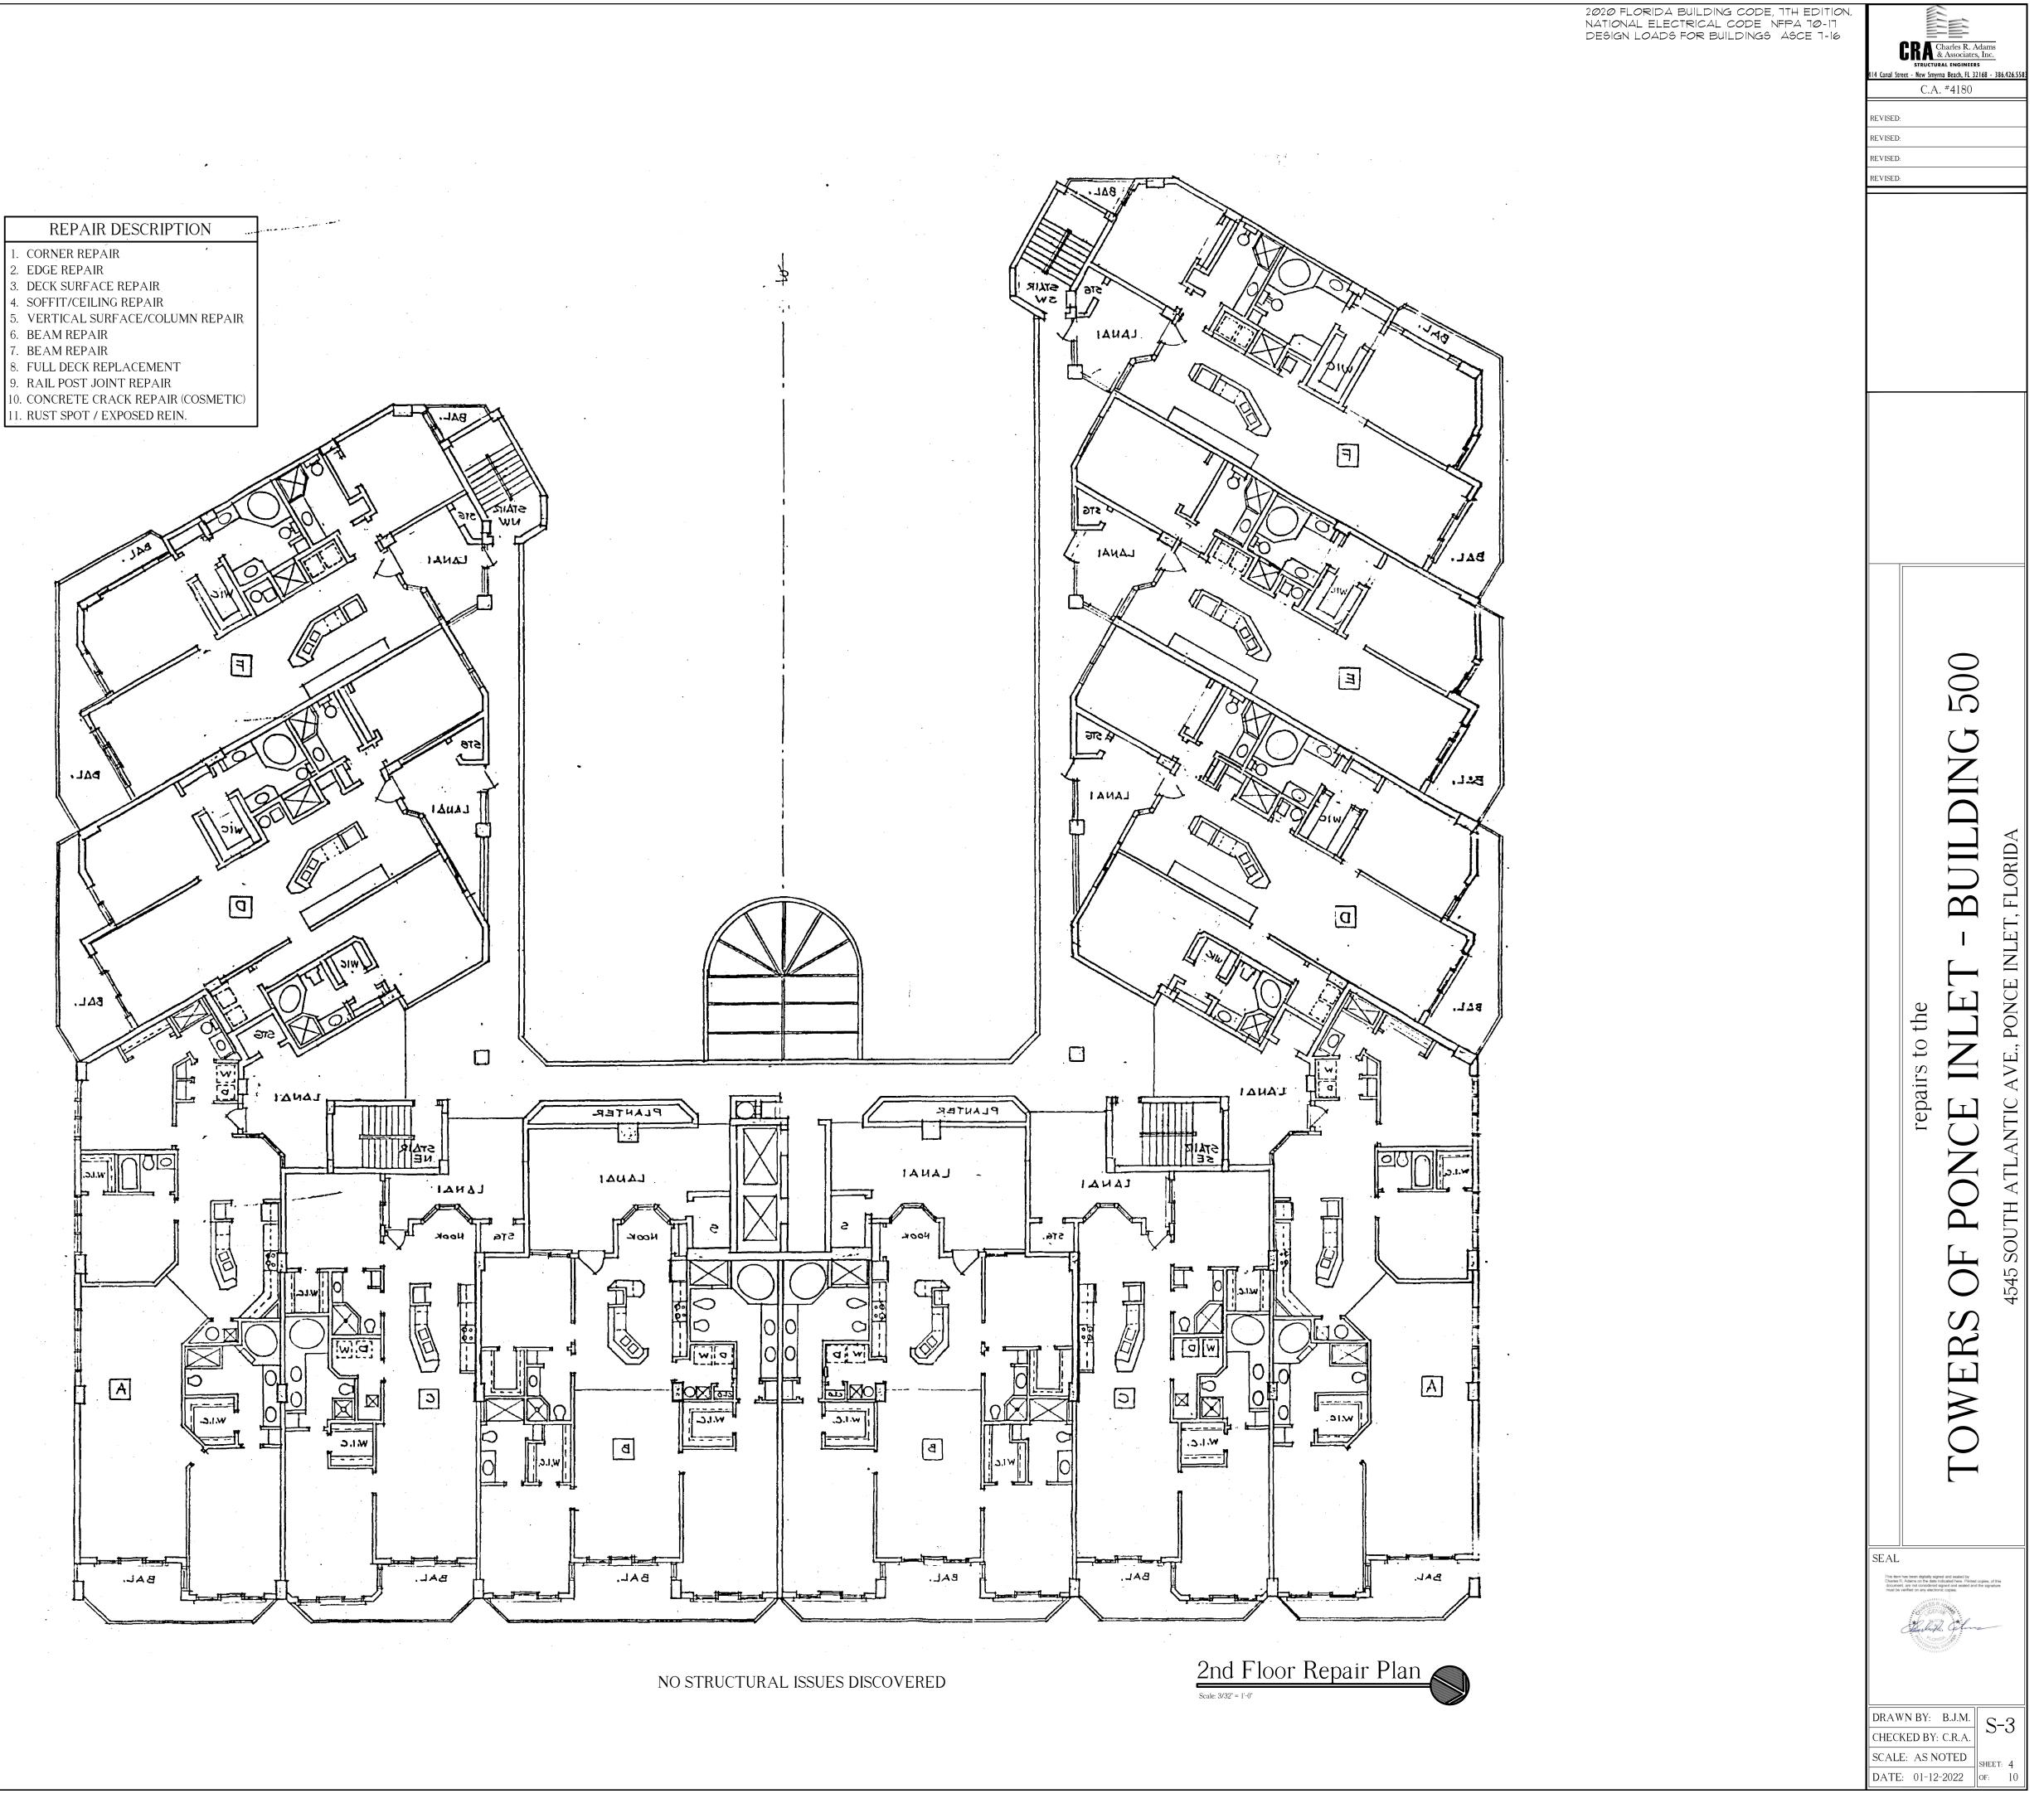

- 1. CORNER REPAIR
- 2. EDGE REPAIR
- 5. VERTICAL SURFACE/COLUMN REPAIR
- 5. BEAM REPAIR
- BEAM REPAIR
- 9. RAIL POST JOINT REPAIR
- 11. RUST SPOT / EXPOSED REIN.

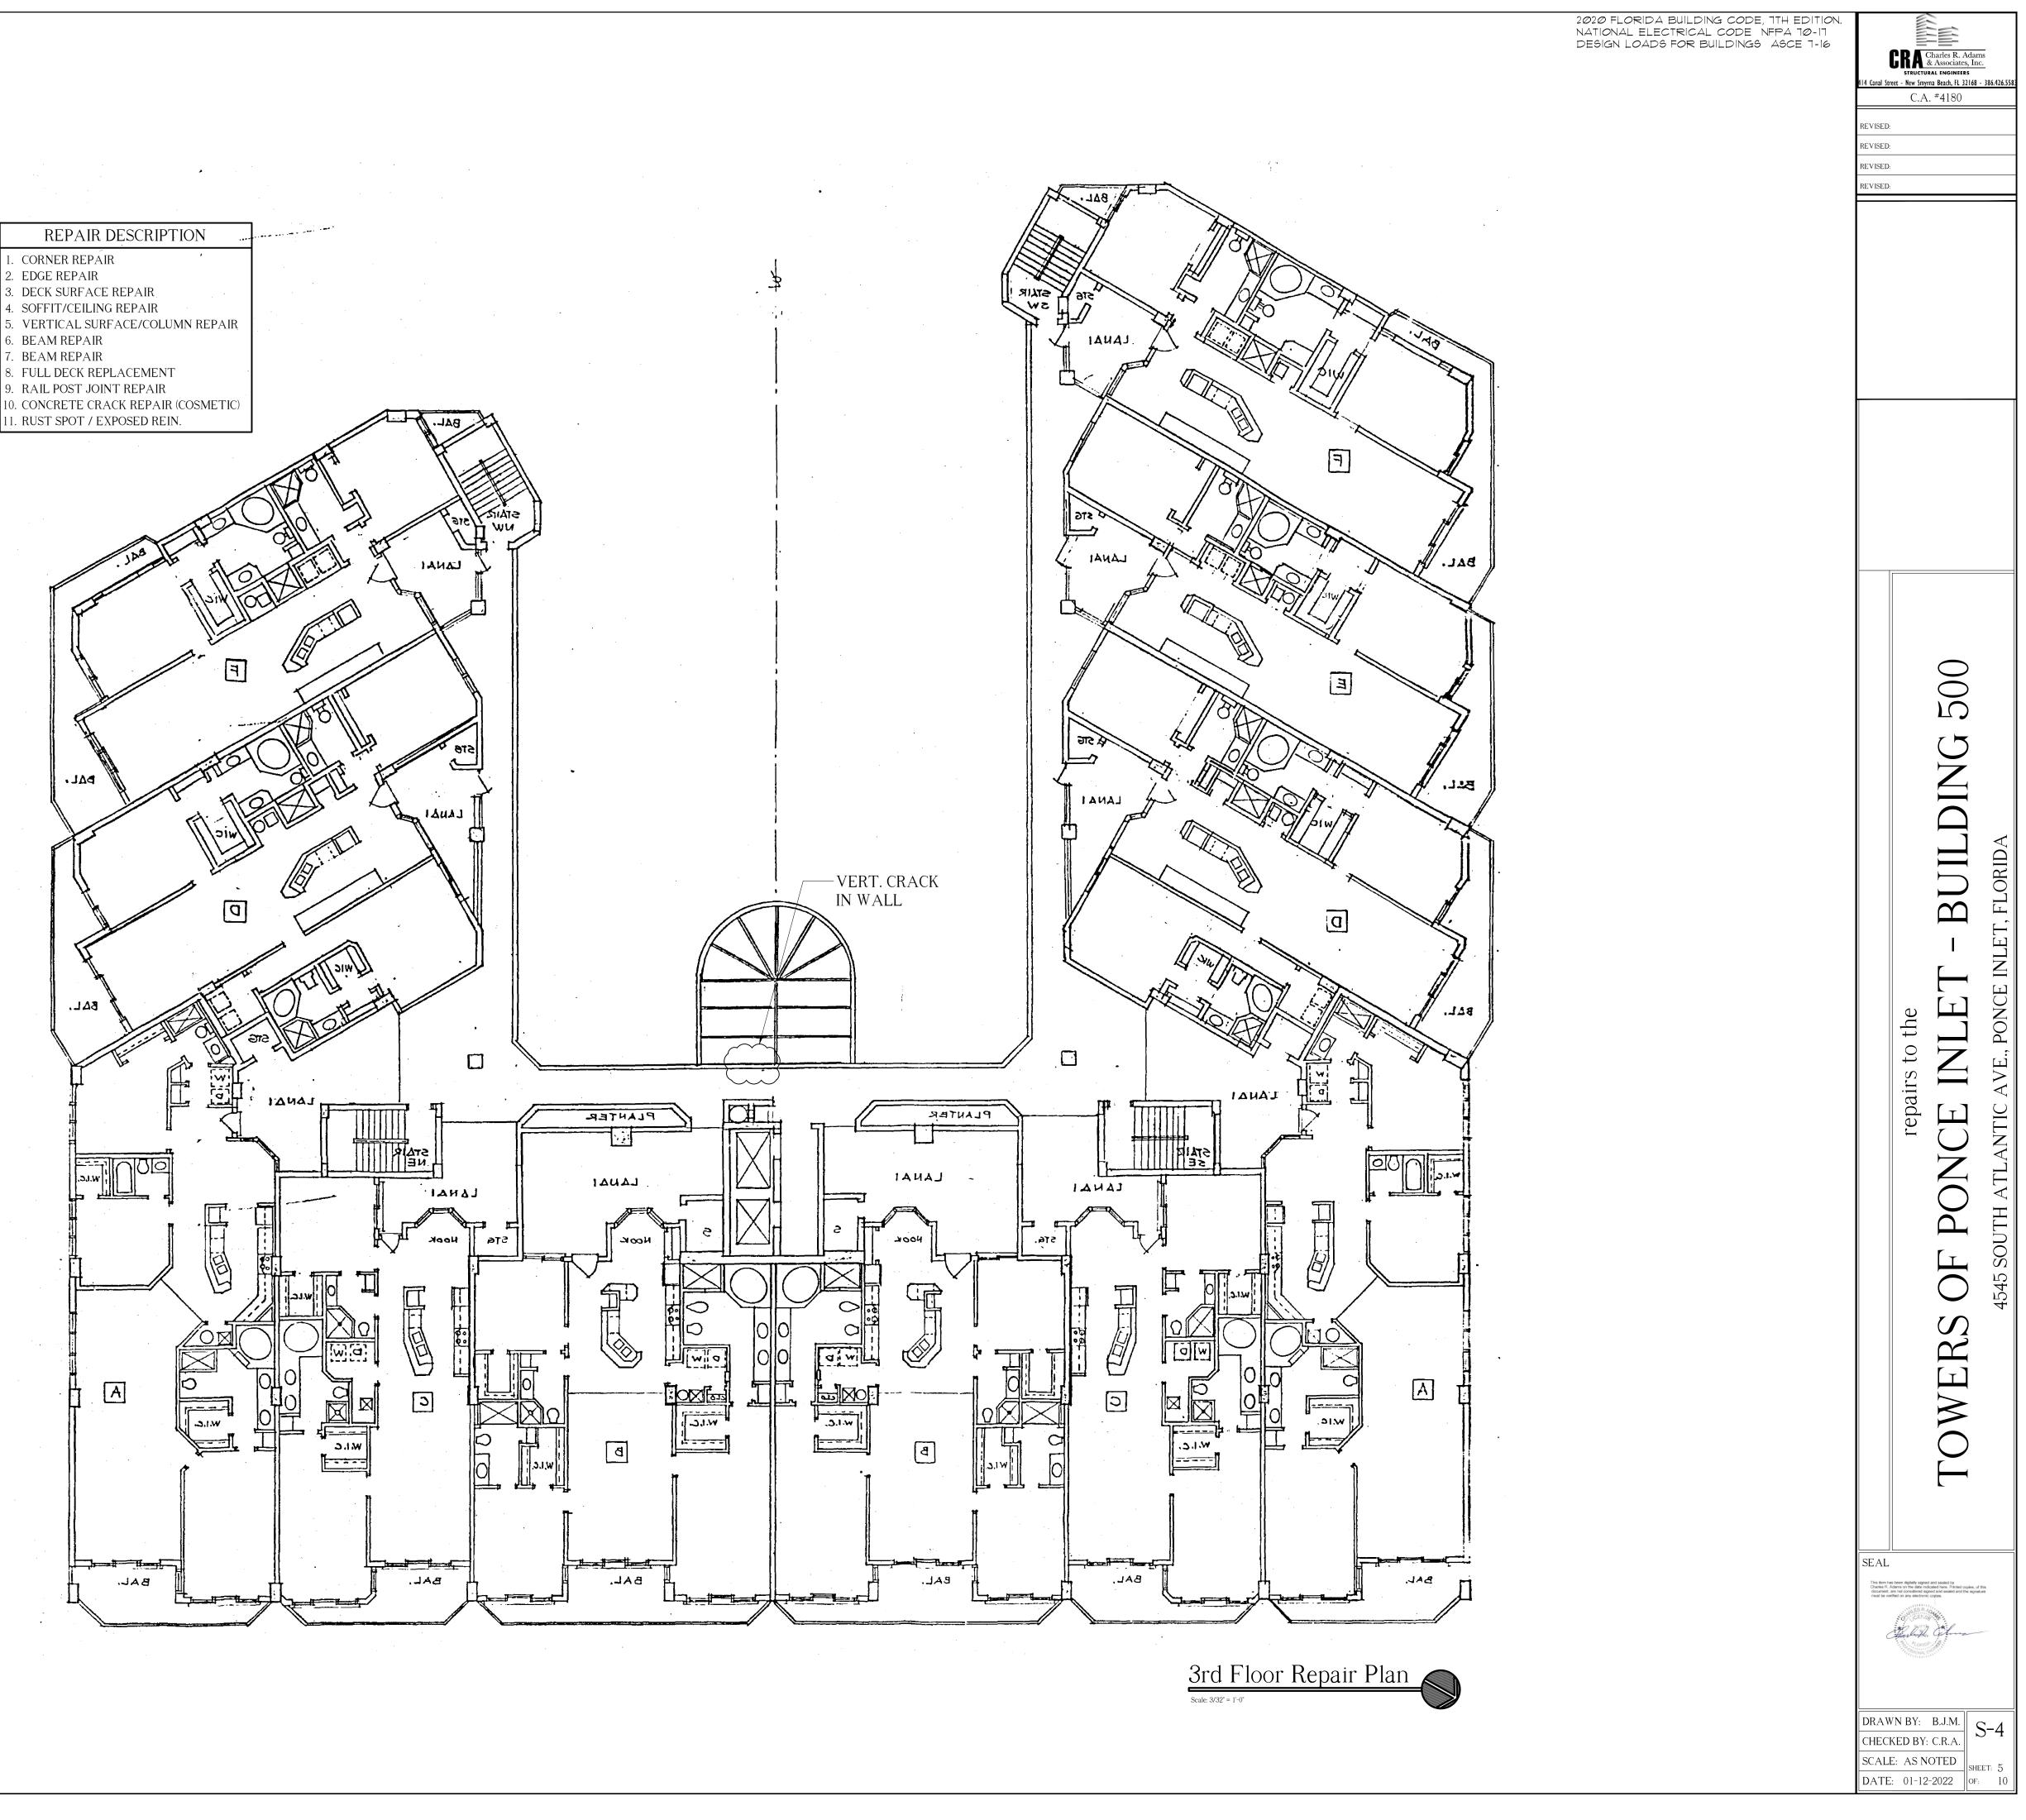


- 1. CORNER REPAIR
- 4. SOFFIT/CEILING REPAIR
- 5. BEAM REPAIR BEAM REPAIR
- 9. RAIL POST JOINT REPAIR
- 11. RUST SPOT / EXPOSED REIN.



- 4. SOFFIT/CEILING REPAIR
- BEAM REPAIR
- **BEAM REPAIR**


- 1. RUST SPOT / EXPOSED REIN.

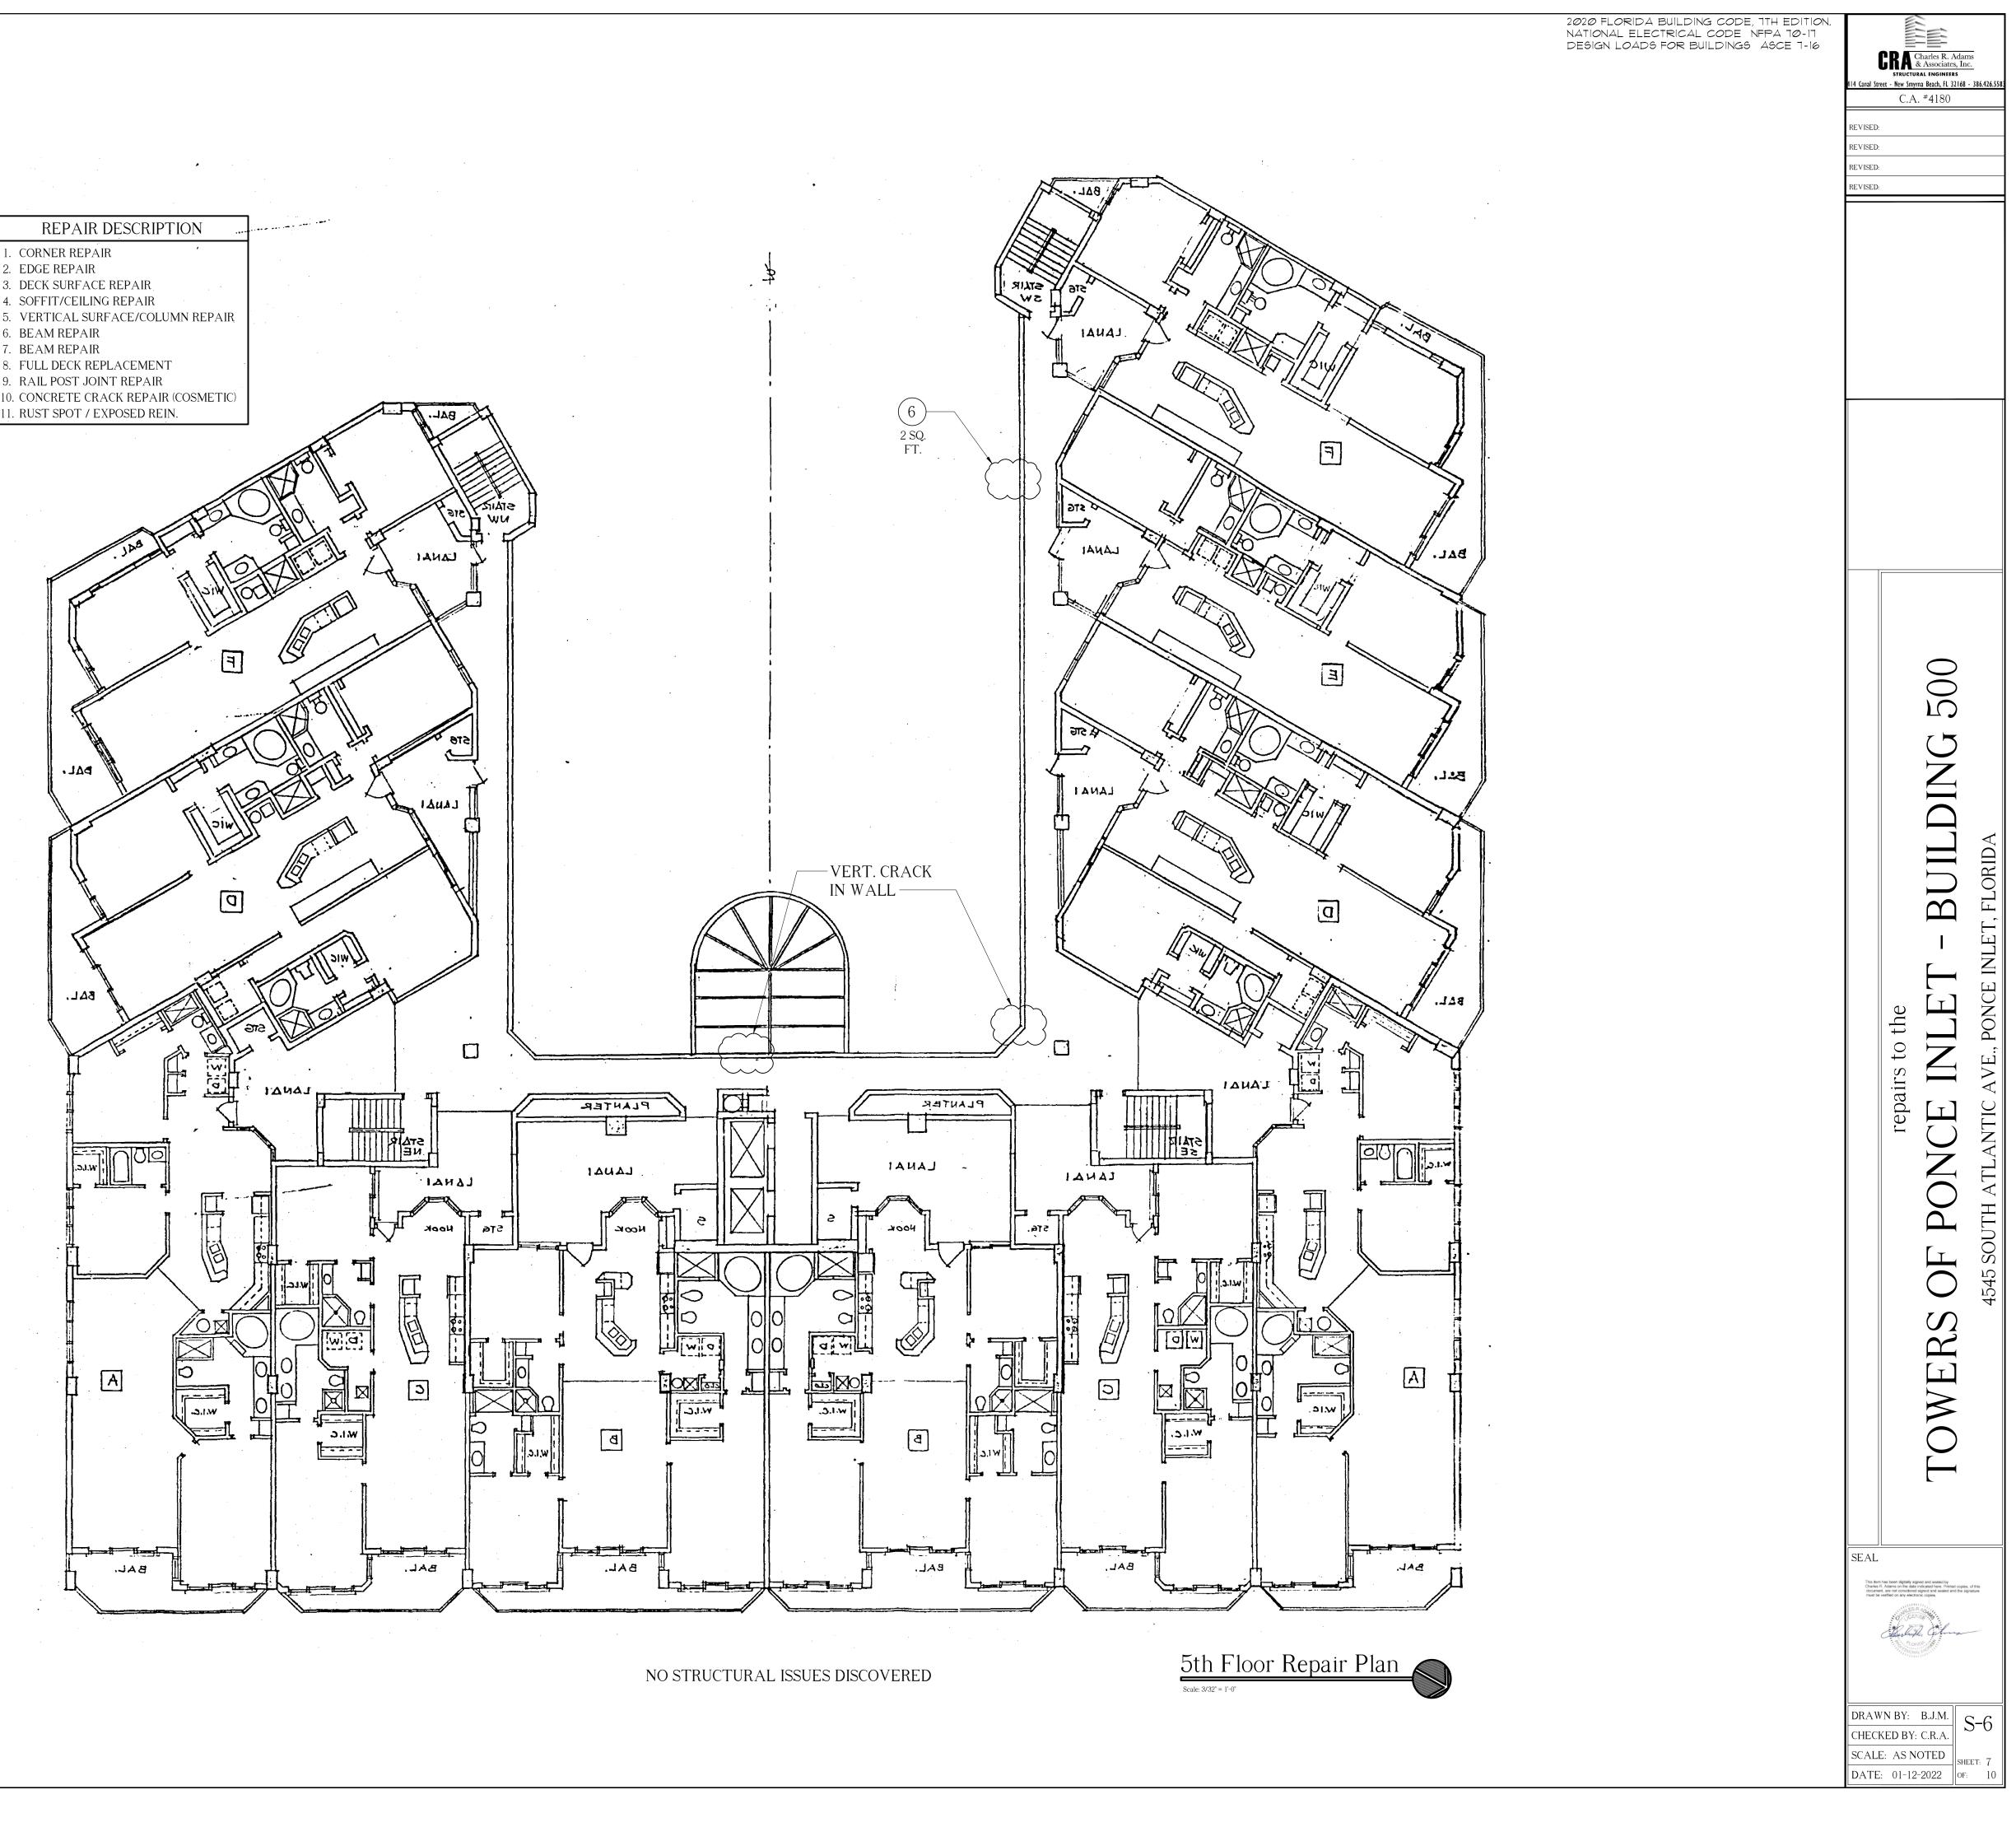

- CORNER REPAIR
- 2. EDGE REPAIR
- 4. SOFFIT/CEILING REPAIR
- 5. BEAM REPAIR

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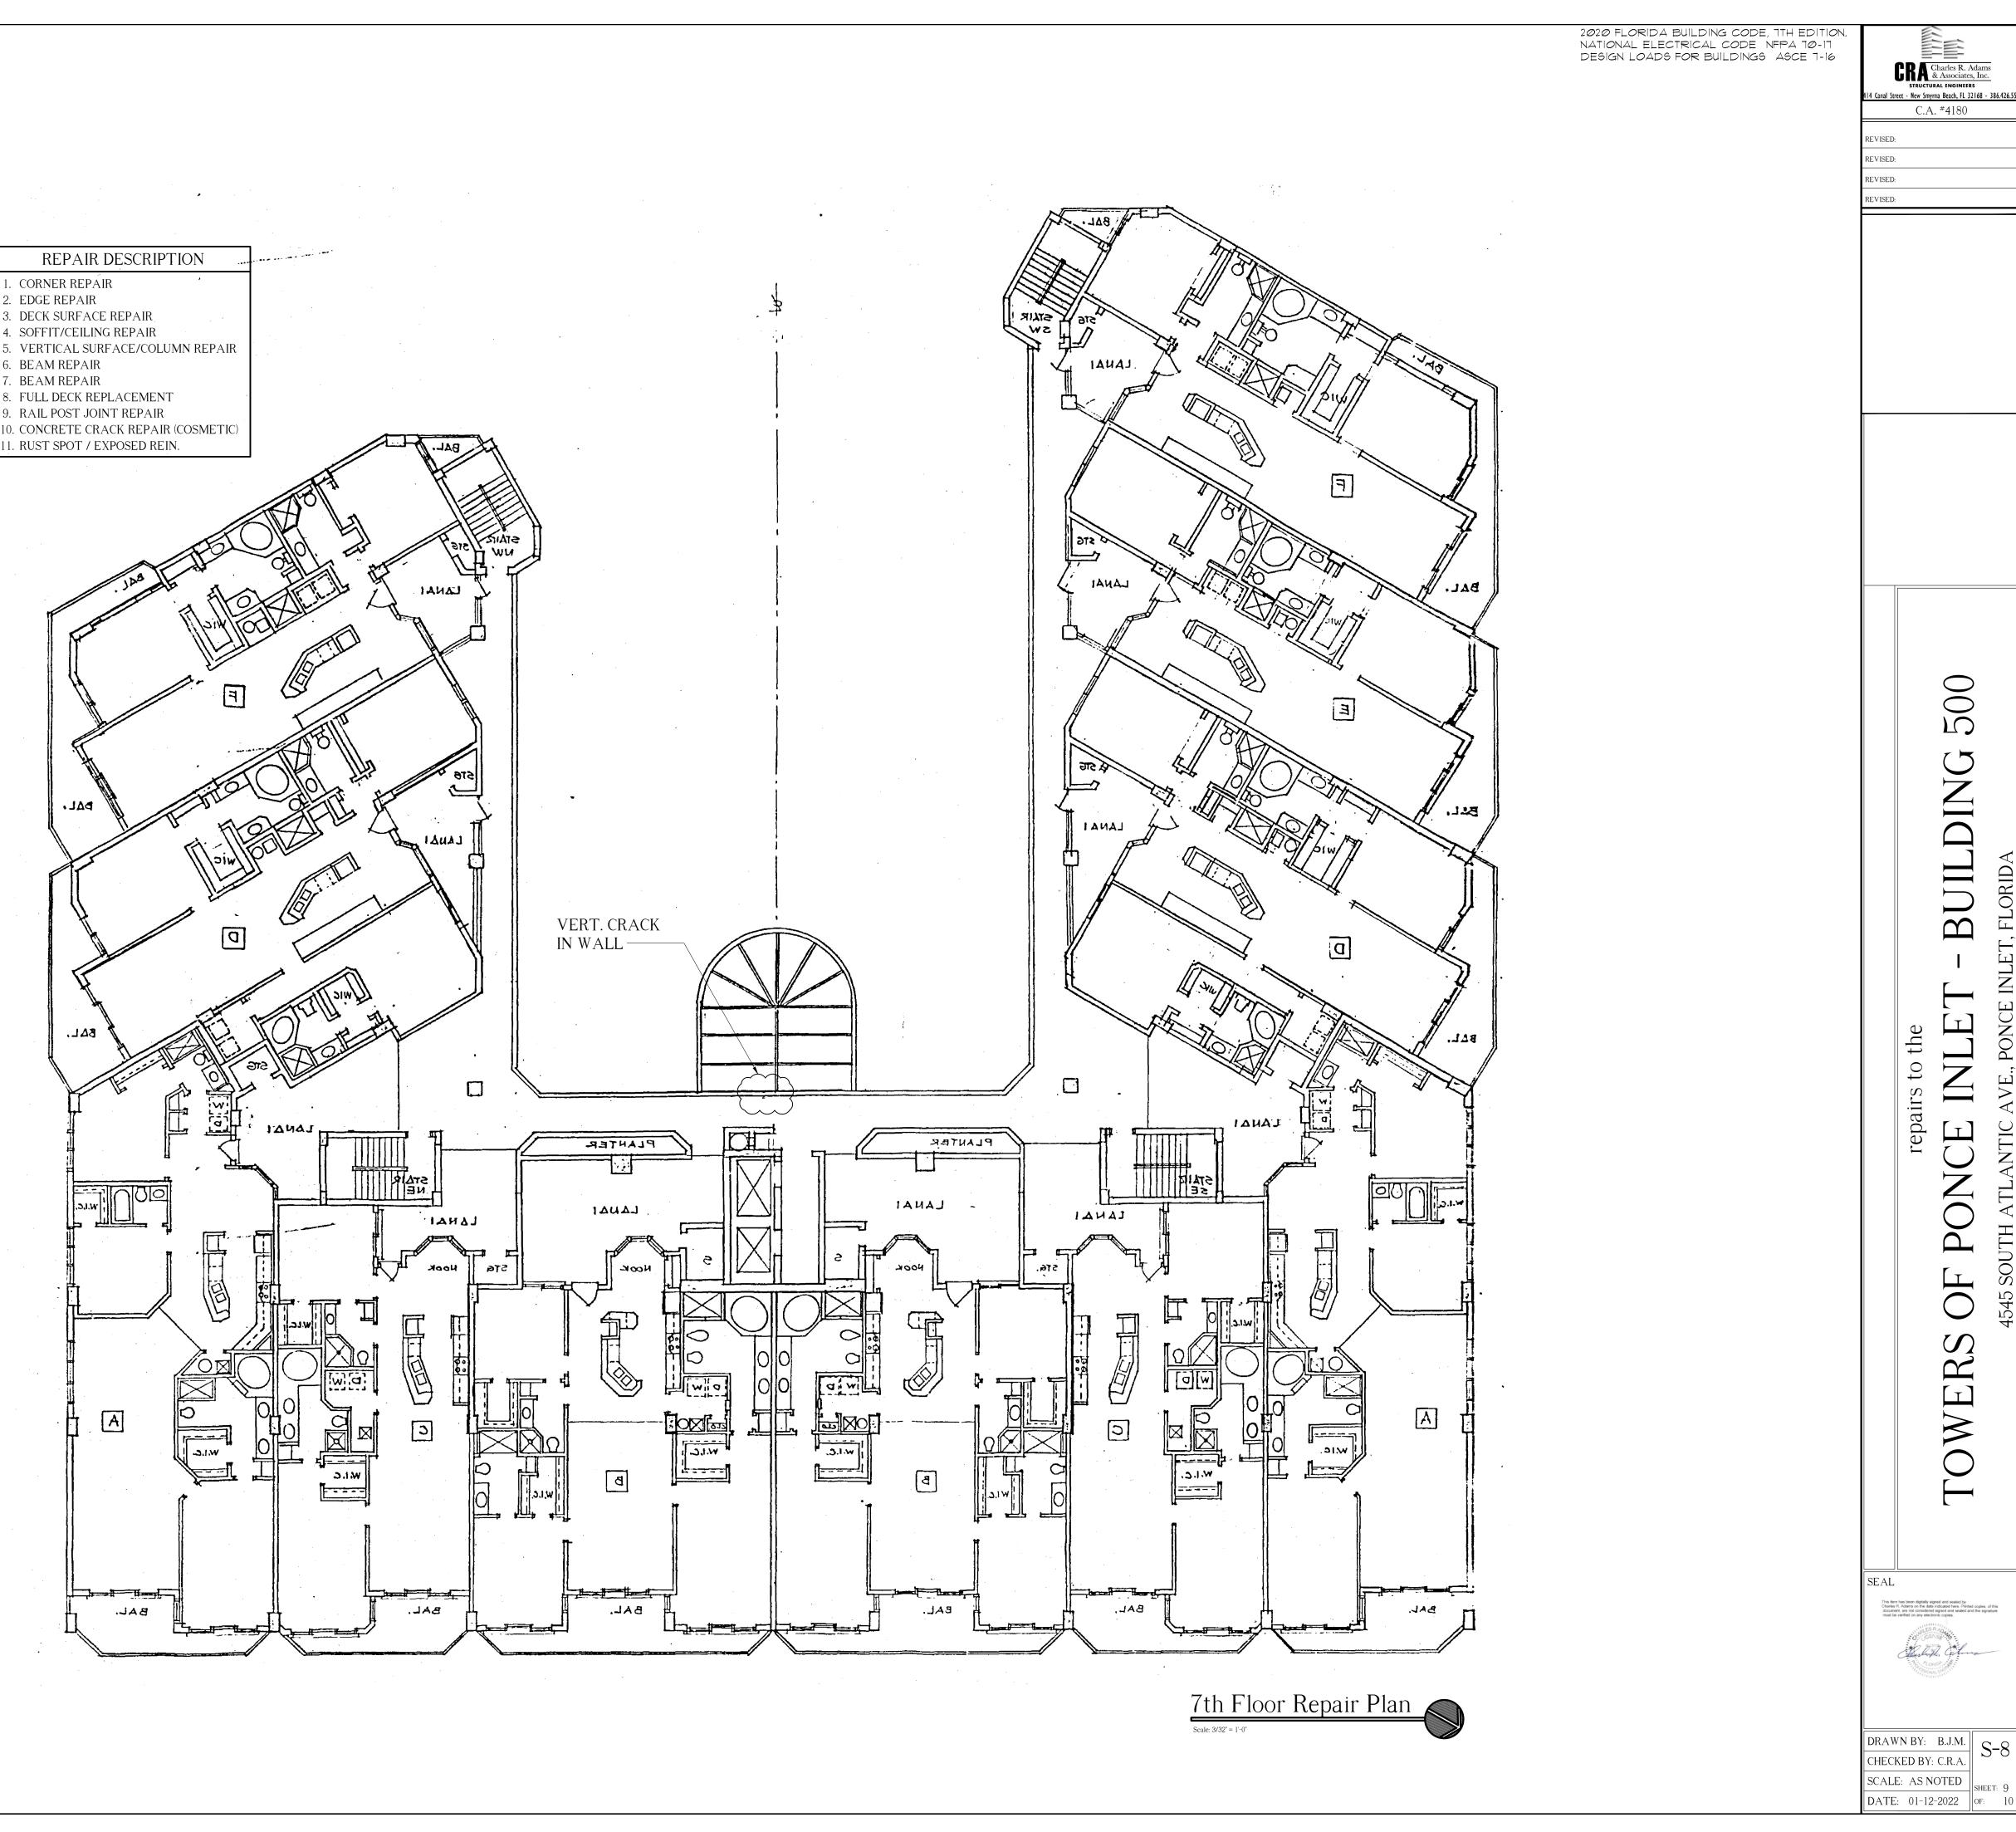
- 9. RAIL POST JOINT REPAIR

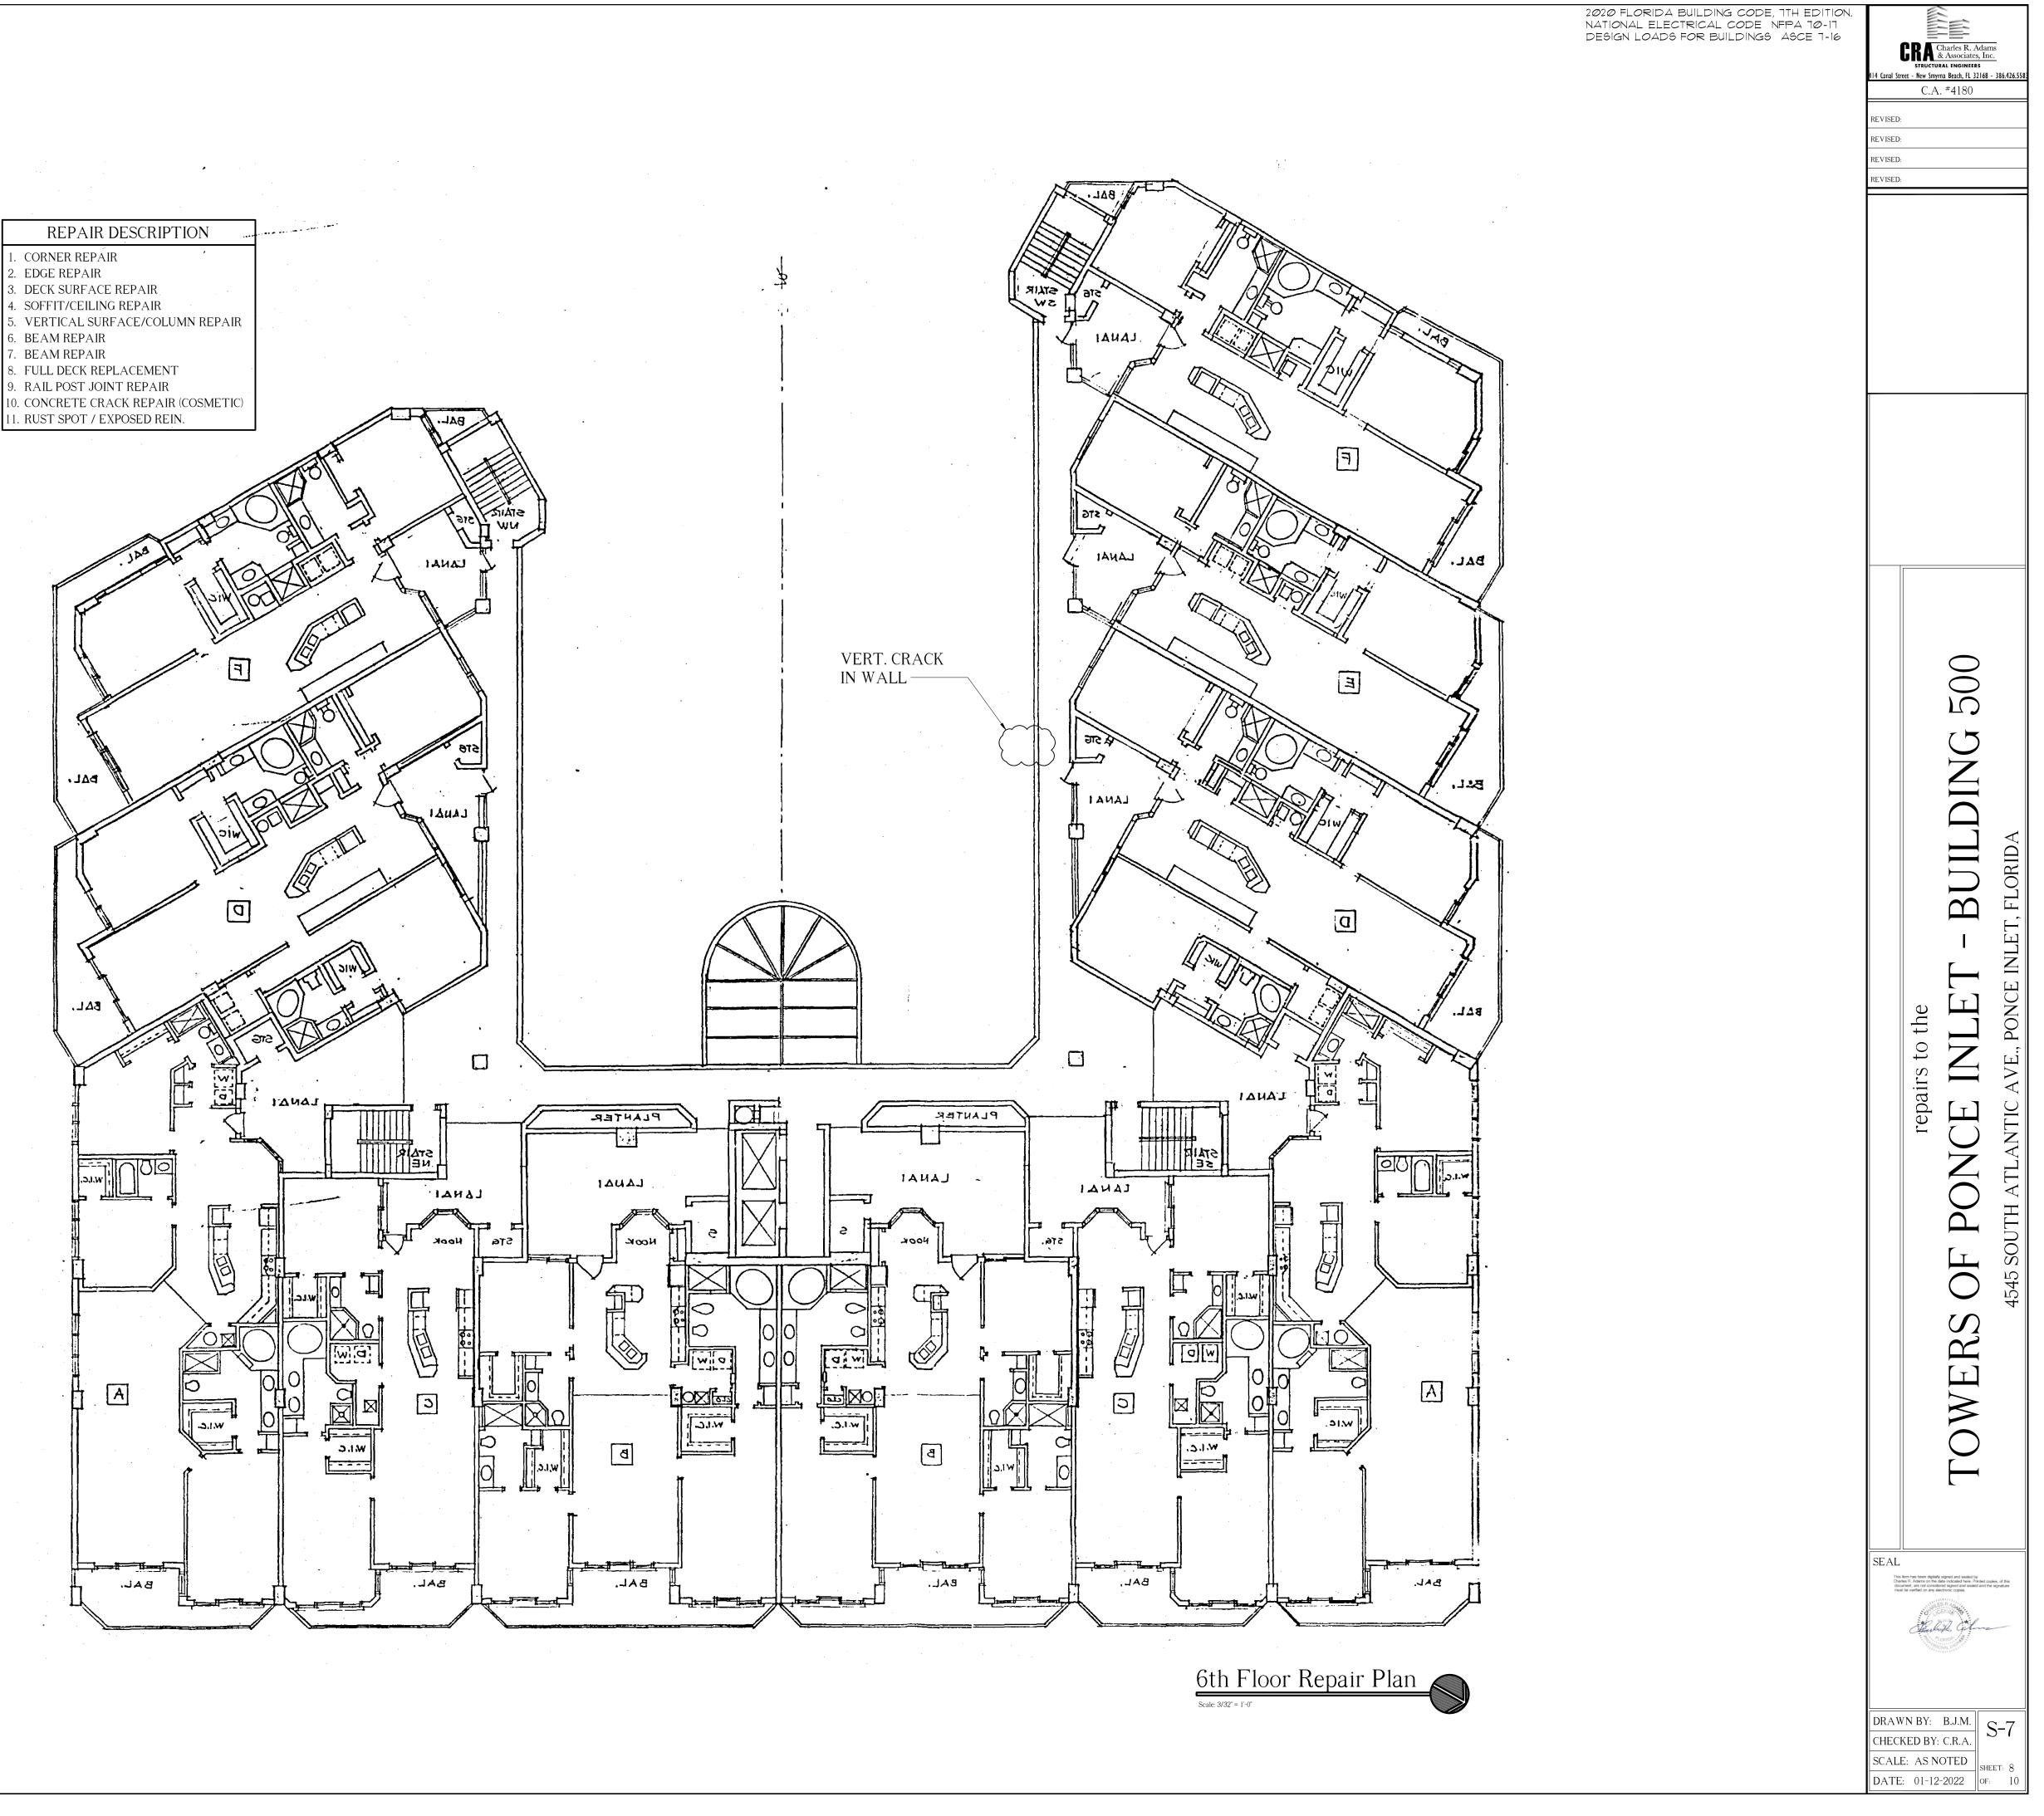


- 2. EDGE REPAIR
- 4. SOFFIT/CEILING REPAIR
- . BEAM REPAIR

•

- 9. RAIL POST JOINT REPAIR



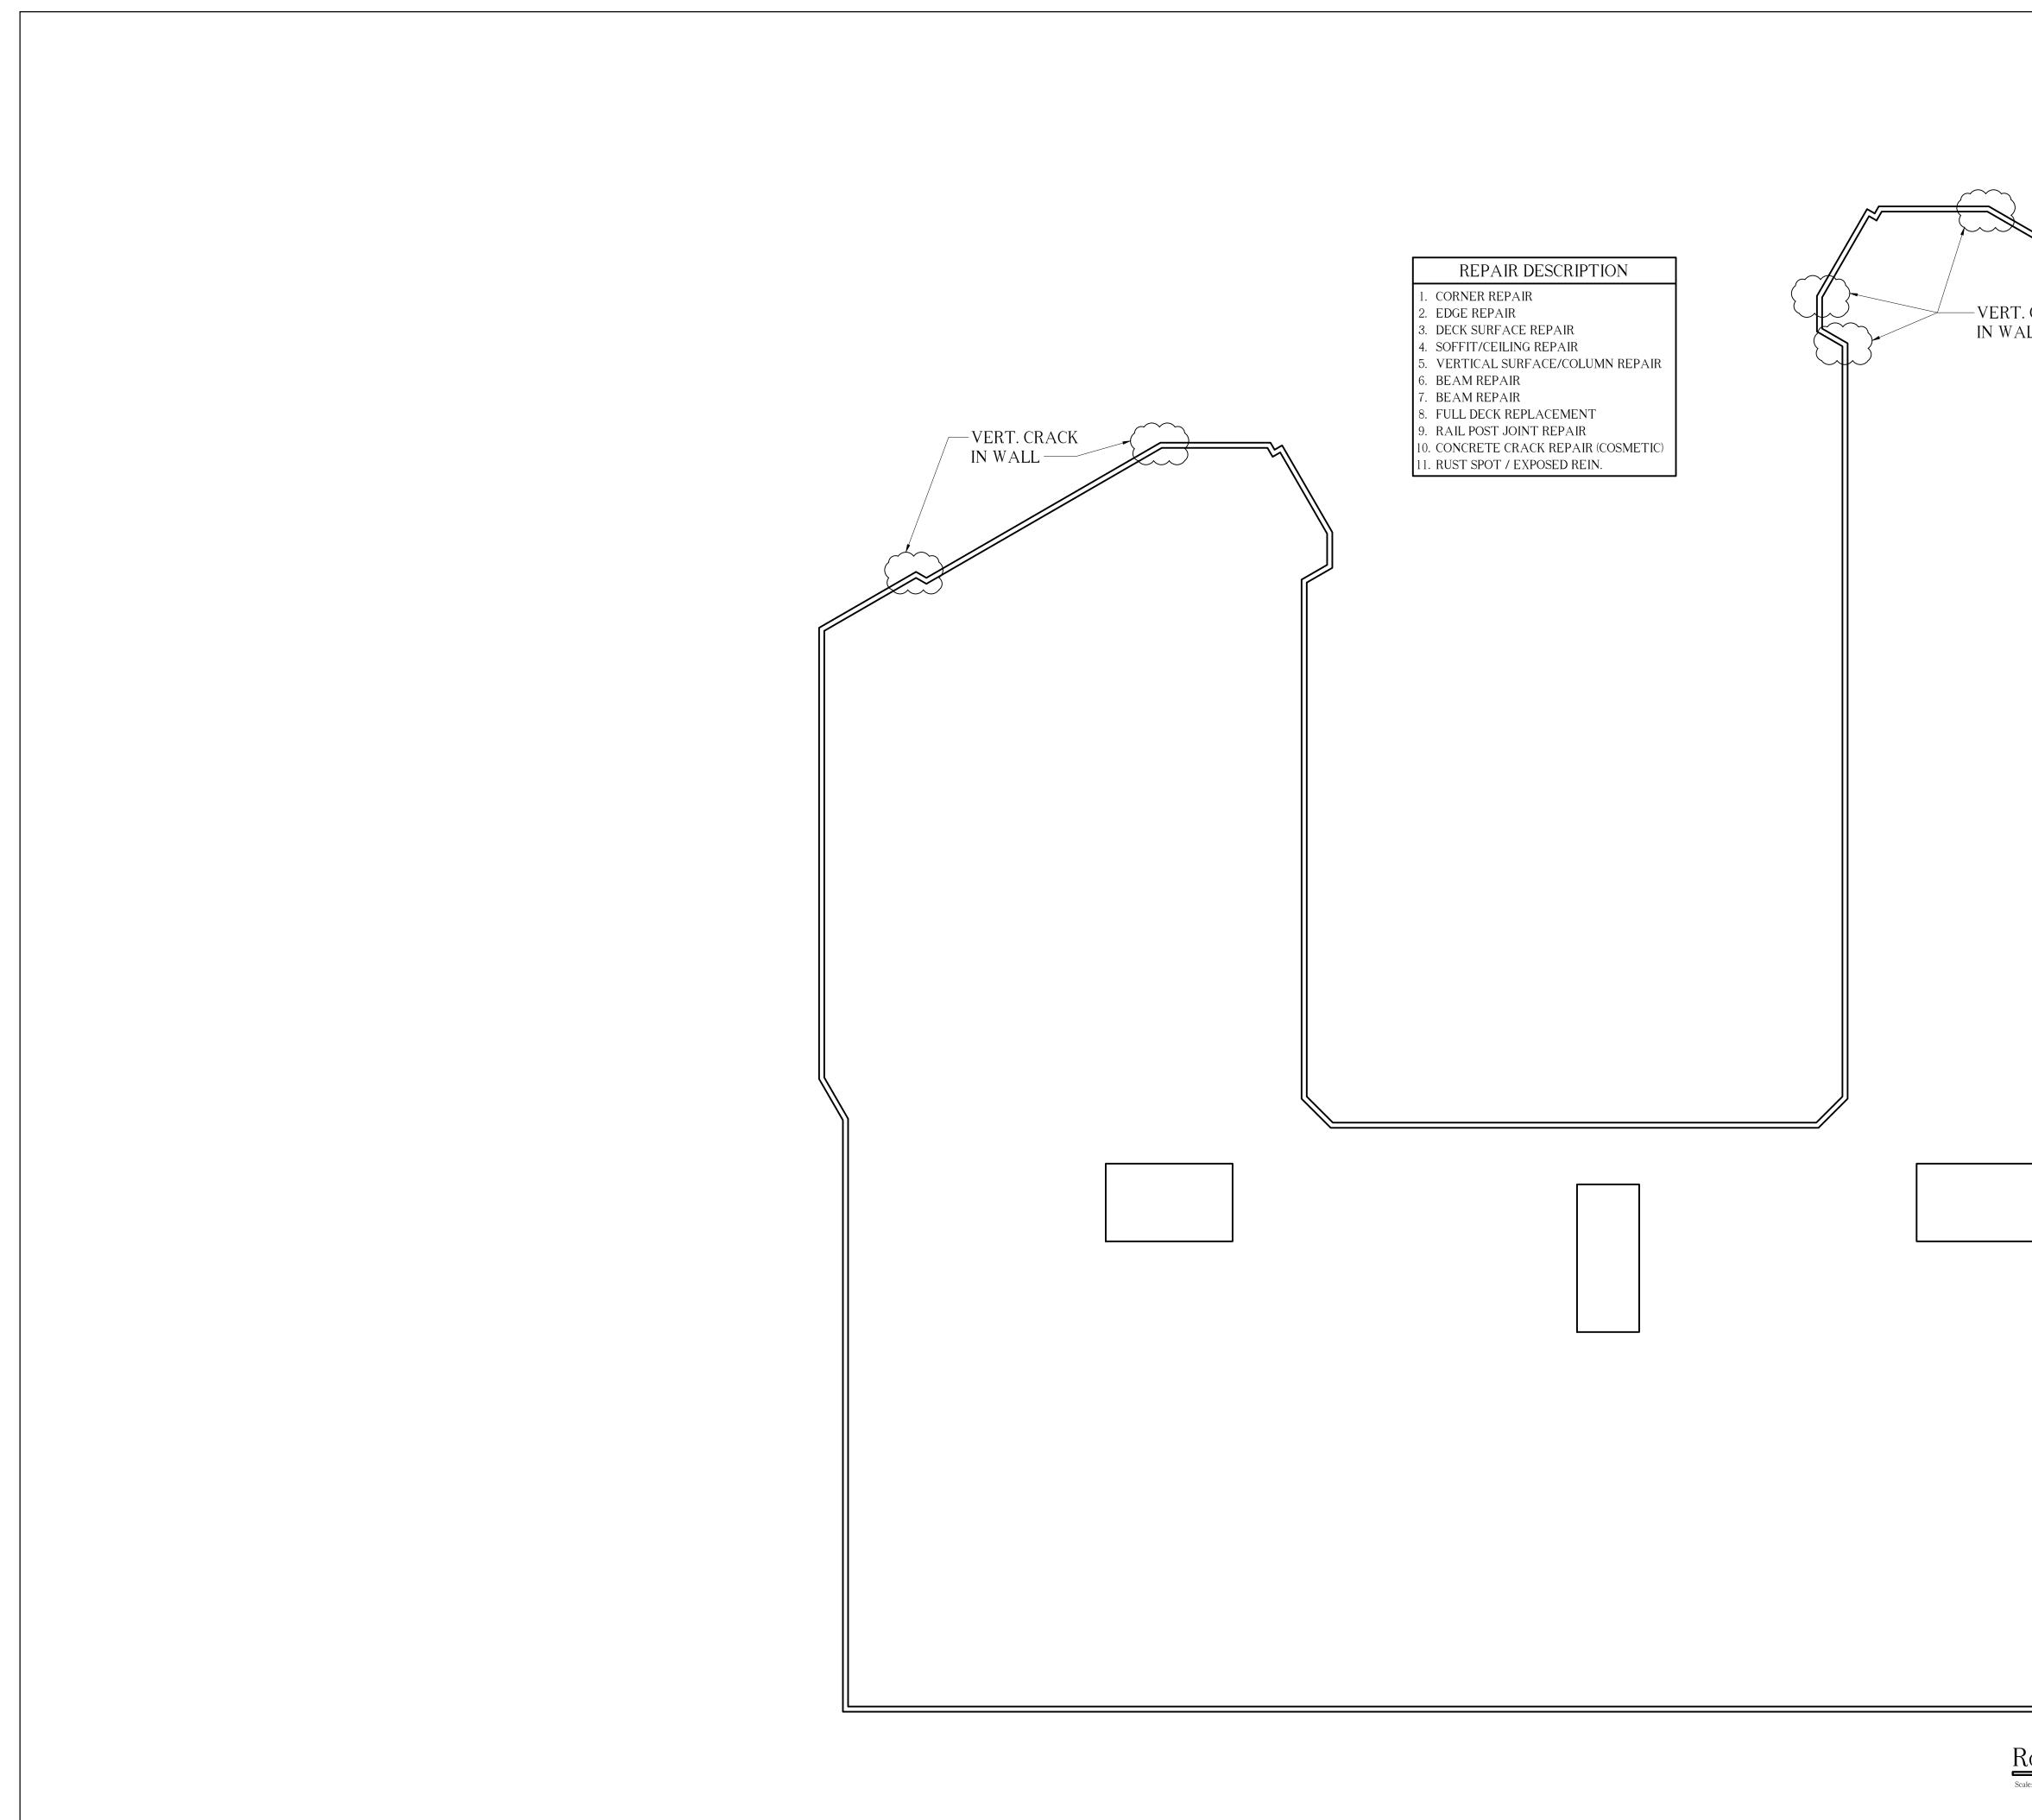

	CRACK	2020 FLORIDA BUILDING CODE, 1TH EDITION. NATIONAL ELECTRICAL CODE NFPA 10-11 DESIGN LOADS FOR BUILDINGS ASCE 1-16	CRA Charles R. Adams STRUCTURAL ENGINEERS 114 Canal Street - New Smyrna Beach, FL 32168 - 386.426.558 C.A. #4180 REVISED: REVISED: REVISED: REVISED:
Coof Repair Plan			
			This tern has been digitally signed and sealed by Charles R. Adarms on the date indicated free Private copies, of this document, are not considered signed and sealed and the signature must be verified on an evel-to-indicate the signature of the signature signature signature signature of the signature signature signature signature of the signature signa